

Zoning: CX-7-PL CAC: East Raleigh Drainage Basin: Crabtree Basin Acreage: 38.98 Sq. Ft.: 124,000

Applicant: Wake Med Hospital



P DEVELOPMENT SERVICES DEPARTMENT

### Administrative Site Review Application (for UDO Districts only)

Development Services Customer Service Center | 1 Exchange Plaza, Suite 400 | Raleigh, NC 27601 | 919-996-2495 | efax 919-996-1831 Litchford Satellite Office | 8320 – 130 Litchford Road | Raleigh, NC 27601 | 919-996-4200

When submitting plans, please check the appropriate building type and include the Plan Checklist document.

		BUILDING T	YPE					FOR O	FFICE USE ONLY
<ul> <li>Detached</li> <li>Attached</li> <li>Apartment</li> <li>Townhouse</li> </ul>			<ul> <li>General</li> <li>Mixed Use</li> <li>Open Lot</li> </ul>				Transaction Number 54623 Assigned Project Coordinator Assigned Team Leader		
Has your project previou	usly been through	the Due Diligence or	Sketch Pla	n Review	process? If ye	s, provide th	e transa	ction #	
Dovolopment Name 1			ENERAL IN	9002-040-040 <u>8-08</u>	ION				
Development Name		1							<b>[</b> ]
Zoning District OX-		Overlay District (if a				Inside Cit	y Limits	? 🔳 Ye	s LINo
Proposed Use Hosp		·	lding		1				
Property Address(es) 3					I		orner	of Falsta	aff and Luther Rd.
Wake County Property I	dentification Nur	nber(s) for each parce	el to which	these guid	elines will ap	ply:			
P.L.N. 17242025	93 <sup>P.I.I</sup>	N.		P.I.N.			P.I.N	•	
What is your project type?  Mixed Residential  Duplex Other: If other, please d	Non-Residenti	al Condo 🛛 🗍 Sc	derly Faciliti hool eligious Insti		] Hospitals ] Shopping Cen ] Residential Co	<sub>ter</sub> [	] Hotels ] <sub>Banks</sub> ] <sub>Retail</sub>	/Motels	<ul> <li>Office</li> <li>Industrial Building</li> <li>Cottage Court</li> </ul>
WORK SCOPE Per City Code Section 10.2.8.D.1, summarize the project work scope. For additions, changes of use, or occupancy (per Chapter 6 of the UDO), indicate impacts on parking requirements. The project proposes to build a 124,000 SF administration building for Wake Med Hospitals. The project will include sanitary sewer, domestic water and fire line improvements as well as updated landscaping and a new 69-space parking lot. Though the number of spaces in the proposed parking lot will fall short of the required 310 spaces, a parking study has been undertaken to determine whether existing parking on the Wake Med campus is adequate for the required number of spaces.									
DESIGN ADJUSTMENT       Per City Code Chapter 8, summarize if your project requires either a design adjustment, or Section 10 - Alternate         OR ADMIN ALTERNATE       Administrative AE         An administrative alternate will be required for using the amenity space near Falstaff Rd. to meet build-to requirements.									
	<sup>Company</sup> Wake Med Hospitals			Name (s)	Name (s) Thomas Cavender				
CLIENT/DEVELOPER/ OWNER	Address 3000 New Bern Ave., Raleigh, NC, 27601								
	Phone 919	.350.8098	Email to	cavenc	ler@wakemed.org				
	Company St	ewart			Name (s)	Joe Pu	icket	t	
CONSULTANT (Contact Person for	Address 42	1 Fayetteville	st., S	uite 40	)0, Ralei	gh, NC	2760	)1	
Plans)		.866.4829			ett@stewartinc.com				

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DEVELOPMENT TYPE & SITE DATA		Γ		
Zoning Information		Building Information		
Zoning District(s) OX-7-PL		Proposed building use(s) Office		
If more than one district, provide the acreage of each:		Existing Building(s) sq. ft. gross N/A		
Overlay District	· · · ·	Proposed Building(s) sq. ft. gross 124,000		
Total Site Acres Inside City Limits $\Box_{\text{Yes}} \Box_{\text{No}} 38.98$		Total sq. ft. gross (existing & proposed)		
Off street parking: Required 310 Provided 59		Proposed height of building(s) 75 ft		
COA (Certificate of Appropriateness) case #		# of stories 3		
BOA (Board of Adjustment) case # A-		Ceiling height of 1 <sup>st</sup> Floor 19 ft		
CUD (Conditional Use District) case # Z-				
Stormwa	ter Information	•		
Existing Impervious Surface 77,966 acres/square feet		Flood Hazard Area 🛛 Yes 🔳 No		
Proposed Impervious Surface 65,657 acres/square feet		If Yes, please provide:		
Neuse River Buffer 🗌 Yes 🔳 No 🦳 Wetlands 🗍 Yes 🔳 N	lo	Alluvial Soils Flood Study FEMA Map Panel #		
FOR RESIDENT	IAL DEVELOPI	MENTS		
1. Total # Of Apartment, Condominium or Residential Units	5. Bedrooi	m Units: 1br 2br 3br 4br or more		
2. Total # Of Congregate Care Or Life Care Dwelling Units	6. Infill De	velopment 2.2.7		
3. Total Number of Hotel Units	7. Open Sp	pace (only) or Amenity		
4. Overall Total # Of Dwelling Units (1-6 Above)	8. Is your j	project a cottage court? Yes No		
SIGNATURE BLOCK (App	plicable to all	developments)		
In filing this plan as the property owner(s), I/we do hereby agree and f and assigns jointly and severally to construct all improvements and ma approved by the City. hereby designate	irmly bind ourse ske all dedicatio	ns as shown on this proposed development plan as		
receive and respond to administrative comments, to resubmit plans or application.	n my behalf and	to serve as my agent regarding this application, to I to represent me in any public meeting regarding this		
/we have read, acknowledge and affirm that this project is conforming use. Signed		1 1		
Printed Name Th mas Chrender	• • • • • • • • • • • • • • • • • • • •			
Signed		Date		
Printed Name				

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**REVISION 05.13.16** 


TO BE COMPLETED BY APPLICANT	TO BE COMPLETED BY CITY STAFF				
General Requirements	YES	N/A	YES	NO	N/A
<ol> <li>Filing Fee for Plan Review – Payments may be made by cash, Visa, Master Card or check made payable to the City of Raleigh</li> </ol>					
2. Administrative Site Review Application_completed and signed by the property owner(s)	Ø			An A	
3. Client must complete and adhere page 1 and 2 of the Administrative Site Review Application to the plan cover sheet	Z				
4. I have referenced the Administrative Site Review Checklist and by using this as a guide, it will ensure that I receive a complete and thorough first review by the City of Raleigh	M		V		
5. Provide the following plan sheets:					
<ul> <li>a) Cover sheet: includes general notes, owner's name, contact's name, telephone number, mailing address and email address</li> </ul>	Q				
b) Existing Conditions Sheet, including, but not limited to, structures, buildings, utilities, infrastructure, and vegetation	Ø				
c) Proposed Site Plan	$\overrightarrow{\mathbf{A}}$				
d) Proposed Grading Plan	$\overline{\mathbf{A}}$				
e) Proposed Stormwater Plan, including preliminary stormwater quantity and quality summary and calculations package. If not required, provide City Code section on front cover.	Ł				
f) Proposed Utility Plan, including Fire	$\overline{\mathbf{v}}$				
g) Proposed Tree Conservation Plan – For secondary Tree Conservation Areas, include two copies of the tree cover report completed by a certified arborist, North Carolina licensed landscape architect, or North Carolina register forester. If not required, provide City Code section on front cover.	₫		~		
h) Proposed Landscape Plan	$\overline{\mathbf{V}}$				
i) Building elevations that show existing and/or proposed building height. If demolition, do not include buildings to be demolished.	¢				
j) Transportation Plan		$\square$			
6. Ten (10) sets of proposed plans to engineering scale (1" = 20', 1" =100', etc.), and date of preparation. <u>For re-submittals – include all revision dates</u>	đ				
7. Minimum plan size 18"x24" not to exceed 36"x42"					
8. A vicinity map no smaller/less than 1"=500' and no larger than 1"=1000' to the inch, showing the position of the plan with its relation to surrounding streets and properties, and oriented in the same direction as the preliminary plan			/		
9. Include sheet index and legend defining all symbols with true north arrow, with north being at the top of the map	ď				
10. Digital copy of only the plan and elevations. Label the CD or flash drive with the plan name, case file number, and indicate the review cycle #.	A	,	~		
11. Wake County School Form, if dwelling units are proposed		Ø			V
12. If applicable, zoning conditions adhered to the plan cover sheet		M			./

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SI	ΓΕ DATA
PROJECT NAME:	WAKE MED
SITE ADDRESS:	3000 NEW BERN AVE
COUNTY:	WAKE
PARCEL PIN #:	1724202593
PARCEL OWNER:	WAKE MED
PARCEL AREA:	38.98 AC
TOTAL DISTURBED/ PROJECT AREA:	2.50 AC
CURRENT ZONING:	OFFICE MIXED USE (OX-7-PL)
EXISTING LAND USE:	HOSPITAL
PROPOSED USE:	HOSPITAL
RIVER BASIN:	CRAB TREE
CONSTRUCTION TYPE:	NEW CONSTRUCTION
MAX BUILDING HEIGHT:	90 FT
PROPOSED BUILDING HEIGHT:	75 FT
EXISTING IMPERVIOUS AREA:	77,966 SF
PROPOSED IMPERVIOUS AREA:	65,657 SF

OVERALL PARKING SUMMARY							
PROVIDED PARKING	REQUIRED	PROVIDED					
REGULAR 9'X18' SPACES	310	56					
REGULAR ACCESSIBLE SPACES	13	3					
TOTAL VEHICULAR PARKING SPACES	323	60					
SHORT-TERM BIKE PARKING	12	12					
LONG-TERM BIKE PARKING	25 25*						
PARKING RATIO: 1 SPACE PER 400 S.F. OF GROSS FLOOR AREA (124,000 SF/400=310 SPACES) BICYCLE PARKING: 1 SPACE PER 10,000 SF OF GROSS FLOOR AREA LONG-TERM BICYCLE PARKING: 1 SPACE PER 5,000 SF OF GROSS FLOOR AREA (124,000 SF/10,000) + (124,000 SF/5,000) = 38 SPACES *LONG-TERM BIKE PARKING LOCATED INSIDE OF BUILDING							
	LONG-TERM BIKE PARKING LOCATED INSIDE OF BUILDING						

IMPERVIOUS SURFACE DATA				
TOTAL AREA OF DISTURBANCE:	118,074 SF			
TOTAL EXISTING IMPERVIOUS AREA:	77,966 SF			
TOTAL PROPOSED IMPERVIOUS AREA:	65,657 SF			
UTILITIES IMPROVEMENTS QTY				

PRIVATE SEWER 8" PVC SEWER SERVICE

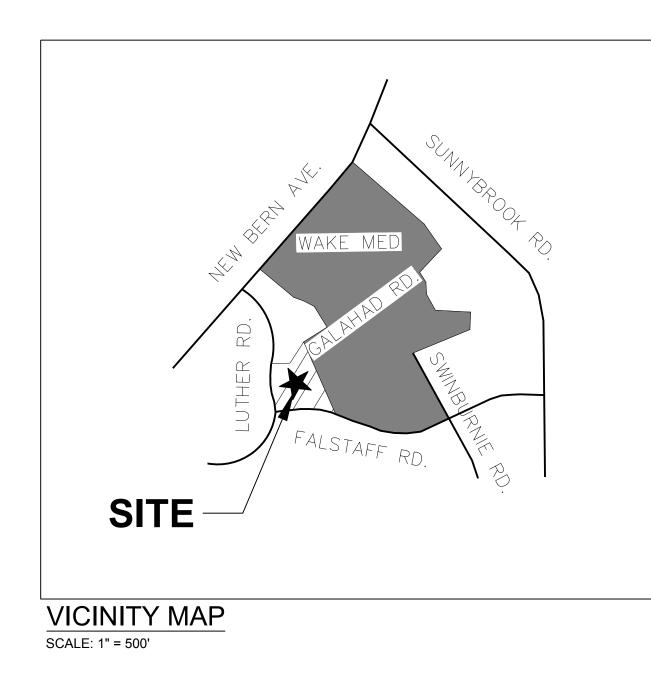PRIVATE WATER

2" COPPER WATERLINE

6" DIP WATERLINE

## APPLICANT/OWNER



WAKE MED HEALTH & HOSPITALS 3000 NEW BERN AVE. RALEIGH, NC 27601 CONTACT: TOM CAVENDER 919.350.8098 (T)

421 FAYETTEVILLE ST., SUITE 400 FIRM LICENSE #: C-1051 www.stewartinc.com PROJECT #: C17117 RALEIGH, NC 27601 T 919.380.8750

STEWART INC. - CIVIL CONTACT: JOE PUCKETT, PE ASSOCIATE MANAGER OF CIVIL ENGINEERING 919.866.4829 (T) 919.380.8752 (F) JPUCKETT@STEWARTINC.COM

# WAKE MED ADMINISTRATION FACILITIES

3000 NEW BERN AVE. RALEIGH, NC 27610

CITY OF RALEIGH SITE PLAN SUBMITTAL

SUBMITTED ON FEBRUARY 20, 2018

	SHEET INDEX
SHEET #	SHEET NAME
C0.00	COVER
C1.00	EXISTING CONDITIONS
C1.10	TREE CONSERVATION PLAN
C2.00	DEMOLITION PLAN
C3.00	SITE PLAN
C3.01	AMENITY SPACE PLAN
C5.00	GRADING AND DRAINAGE PLAN
C6.00	UTILITY PLAN
C9.00	SITE DETAILS
C9.01	SITE DETAILS
C9.02	SITE DETAILS
C9.20	GRADNG AND STORMWATER DETAILS
C9.30	UTILITY DETAILS
C9.31	UTILITY DETAILS
L1.00	PLANTING PLAN
L2.00	PLANTING DETAILS
A2.03	BUILDING ELEVATIONS
A2.04	BUILDING ELEVATIONS

## **CIVIL ENGINEERING - LANDSCAPE ARCHITECTURE**



770 LF

46 LF 43 LF

STEWART INC. - LANDSCAPE ARCHITECTURE CONTACT: JENNIFER WAGNER, PLA LANDSCAPE ARCHITECT 919.866.4739 (T) 919.380.8752 (F) JWAGNER@STEWARTINC.COM



ARCHITECTS

GENSLER 530 HILLSBOROUGH STREET RALEIGH, NC 27603 CONTACT: BRAD BURNS 919.327.1868 (T) 919.239.7829 (F) BRAD\_BURNS@GENSLER.COM

## Administrative Site Review Application (for UDO Districts only)




Development Services Customer Service Center   1 Exchange Plaza, Suite 400   Raleigh, NC 27601   919-996-2495   efax 919-996-1831 Litchford Satellite Office   8320 – 130 Litchford Road   Raleigh, NC 27601   919-996-4200							
When sub	mitting plans, p	lease check the app	ropriate building ty	pe and inclu	ude the Plai	n Checklist do	ocument.
		BUILDING TYP	E			FOR	OFFICE USE ONLY
Detached     General       Attached     Mixed Use       Apartment     Open Lot				Assign	ransaction Number ned Project Coordinator signed Team Leader		
Has your project previou	sly been through t	the <b>Due Diligence or S</b>	<b>ketch Plan Review</b> pr	ocess? If yes,	provide the	transaction #	
Development Name and				DN			
Development Name W							
Zoning District OX-	7-PL	Overlay District (if ap	plicable)		Inside City	Limits? الا	res □ <sub>No</sub>
Proposed Use Hospi	ital Admini	stration Build	ling				
Property Address(es) 3(	000 New B	ern Ave.		Major Street	Locator: Co	orner of Fals	taff and Luther Ro
Wake County Property Io	dentification Num	ber(s) for each parcel	to which these guidel	ines will app	ly:		
P.I.N. 172420259	93 <sup>P.I.N</sup>		P.I.N.			P.I.N.	
					<ul> <li>Office</li> <li>Industrial Buildin</li> <li>Cottage Court</li> </ul>		
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DESIGN ADJUSTMENT OR ADMIN ALTERNATE	Administrative AE						
	Company Wake Med Hospitals Name (s) Thomas C			s Caveno	ler		
CLIENT/DEVELOPER/ OWNER	Address 300	00 New Bern	Ave., Raleigh	, NC, 27	7601		
	Phone <b>919</b> .	350.8098	Email tcavende	er@wak	emed.o	rg <sup>Fax</sup>	
	Company Ste	ewart		Name (s)	Joe Pu	ckett	
CONSULTANT (Contact Person for	Address 42	1 Fayetteville	St., Suite 400	), Ralei	gh, NC 2	27601	
Plans)	Phone 919.	866.4829	Email jpucke	tt@stew	vartinc.c	om Fax	
PAGE 1 OF 3		WWW	RALEIGHNC.	.GOV		REV	VISION 05.13.1

DEVELOPMENT TYPE & SITE DATA	TABLE (Appli	cable to all developments)		
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Proposed Impervious Surface 65,657 acres/square feet		If Yes, please provide:		
Neuse River Buffer 🛛 Yes 🔲 No Wetlands 🖓 Yes 🛄 N	No	Alluvial Soils Flood Study FEMA Map Panel #		
FOR RESIDENT	AL DEVELOP	MENTS		
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In filing this plan as the property owner(s), I/we do hereby agree and f and assigns jointly and severally to construct all improvements and m approved by the City. I hereby designate receive and respond to administrative comments, to resubmit plans o application.	ake all dedication	ons as shown on this proposed development plan as		
I/we have read, acknowledge and affirm that this project is conformin use. Signed Thomas Covendar Printed Name				
SignedDateDate				
Printed Name				

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**REVISION 05.13.16** 




RVE	Y LEGEND:
	SURVEY CONTROL POINT
	FOUND IRON PIPE/ROD/PKNAIL
	STORM DRAIN MANHOLE
	STORM DRAIN CURB INLET
	SANITARY SEWER MANHOLE
	HYDRANT
	WATER VALVE
	GAS VALVE
NP	FIBER OPTIC WITNESS POST
	FIBER OPTIC BOX
	ELECTRIC BOX
	UTILITY POLE
	GUY WIRE
	LIGHT POLE
	JUNCTION BOX
	BOLLARD
	SIGN
8'	FINISHED FLOOR ELEVATION
	DECIDUOUS TREE
	EVERGREEN TREE
	BUSH
	CHAIN LINK FENCE
$\sim$	EDGE OF VEGETATION
	UNDERGROUND FIBER OPTIC LINE
	UNDERGROUND GAS LINE
	UNDERGROUND ELECTRIC LINE
	UNDERGROUND WATER LINE
	SANITARY SEWER LINE
_	STORM DRAIN LINE
	OVERHEAD WIRES
-	UNKNOWN DESTINATION
₹.	CONCRETE SURFACE
	DUCTILE IRON PIPE
	POLYVINYL CHLORIDE PIPE
	REINFORCED CONCRETE PIPE
	CORRUGATED METAL PIPE

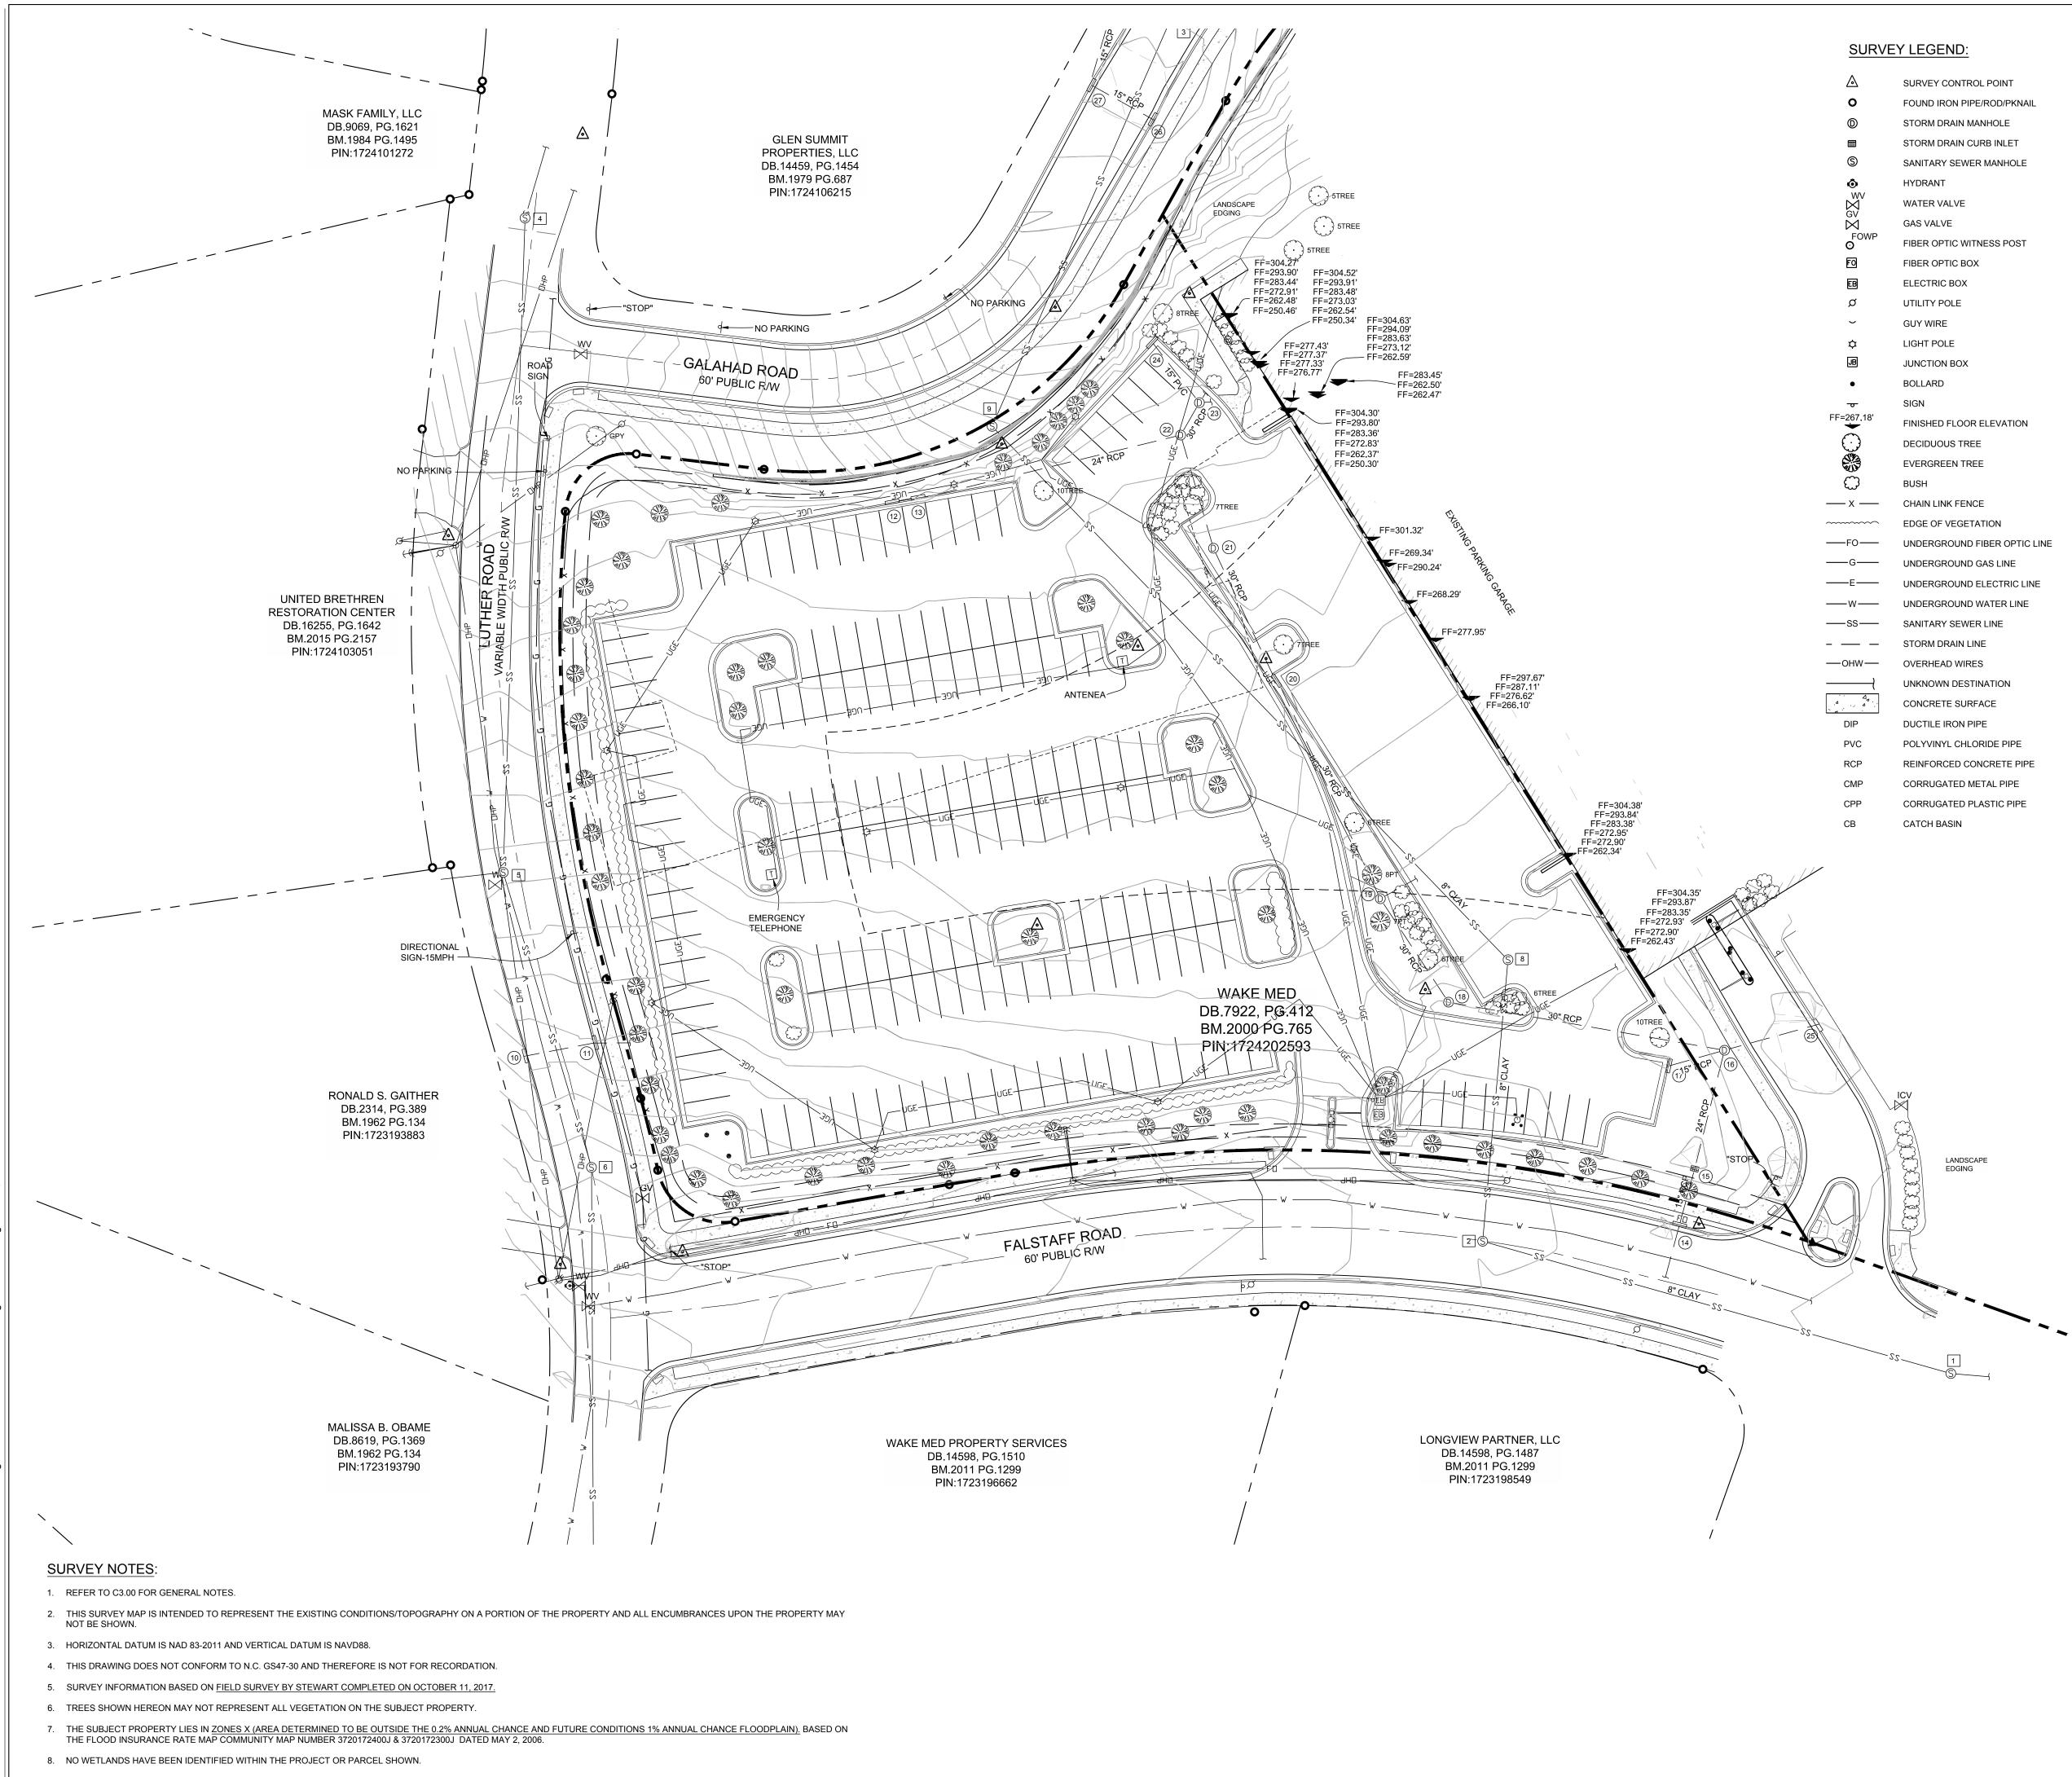
- SANITARY SEWER TABLE
  - 1 MANHOLE RIM=264.31' SW INV=256.16' NE INV=256.26' S INV=256.96'
  - 2 MANHOLE RIM=262.48' N INV=254.33' SE INV=254.98'
  - 3 MANHOLE RIM=228.94' W INV=224.06" NE INV=225.59' E INV=261.71'
  - 4 MANHOLE RIM=245.05' S INV=238.60' NE INV=238.27'
  - 5 MANHOLE RIM=257.80' W INV=248.85' SE INV=248.50' N INV=248.42'
  - 6 MANHOLE RIM=264.84' S INV=257.53' NW INV=257.23'
  - 7 MANHOLE RIM=274.49' N INV=268.78'
  - 8 MANHOLE RIM=258.22' NW INV=240.93' S INV=240.96'
  - 9 MANHOLE RIM=236.10' SE INV=230.10' NE INV=228.10'
- TOC=262.15' INV OUT=258.62' (11) CATCH BASIN
- TOC=261.80' INV IN=258.40' INV OUT=258.25'
- (12) CATCH BASIN TOC=250.43' INV OUT=246.49' (13) CATCH BASIN TOC=250.50' SE INV IN=245.92'
- SW INV IN=246.26' INV OUT=245.89' (14) CATCH BASIN TOC=261.47' N INV=256.87'
- S INV=256.97' DRAIN INLET TOP=258.67' NE INV=255.72' SE INV=255.77'
- (16) SDMH RIM=261.61' SE INV=250.71' SW INV=250.76' SWW INV=253.88' NW INV=250.56'
- (17) CATCH BASIN TOC=259.20' NE INV=254.35'
- (18) SDMH RIM=259.29' SE INV=248.44' NW INV=248.39'

- STORM DRAINAGE TABLE (10) CATCH BASIN (19) SDMH RIM=257.55'
  - SE INV=247.65' NW INV=246.60' NE INV=252.15' (20) CATCH BASIN
    - TOC=255.38' NW INV=245.45' SE INV=245.54'
    - (21) SDMH RIM=253.28' NW INV=244.18' SE INV=244.28'
    - (22) SDMH RIM=251.52' NE INV=242.27' SE INV=241.37' SW INV=244.32'
    - (23) SDMH RIM=251.18' NE INV=243.48' E INV=241.75' SW INV=241.83' NW INV=244.78'
    - (24) CATCH BASIN TOC=250.95' SE INV=245.47' (25) CATCH BASIN


TOC=261.96'

- SW INV=254.46' 26 CATCH BASIN TOC=227.90' NW INV=220.46'
- (27) CATCH BASIN TOC=227.84' NE INV=219.84' SE INV=219.91'

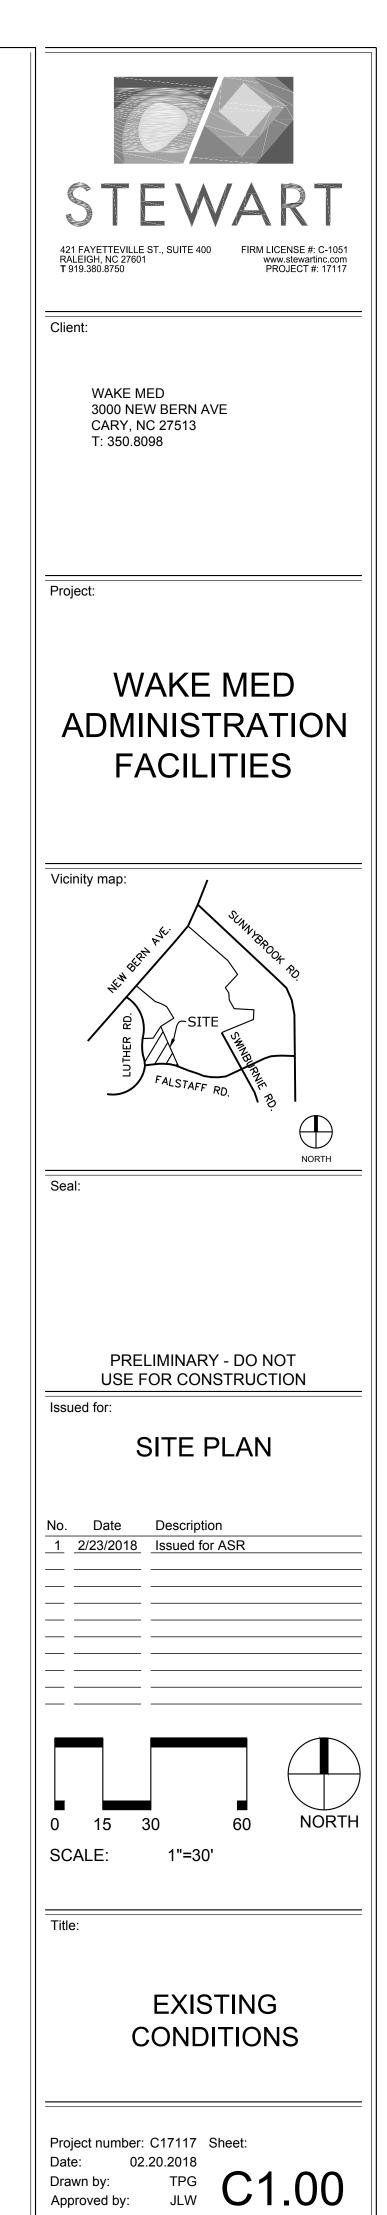

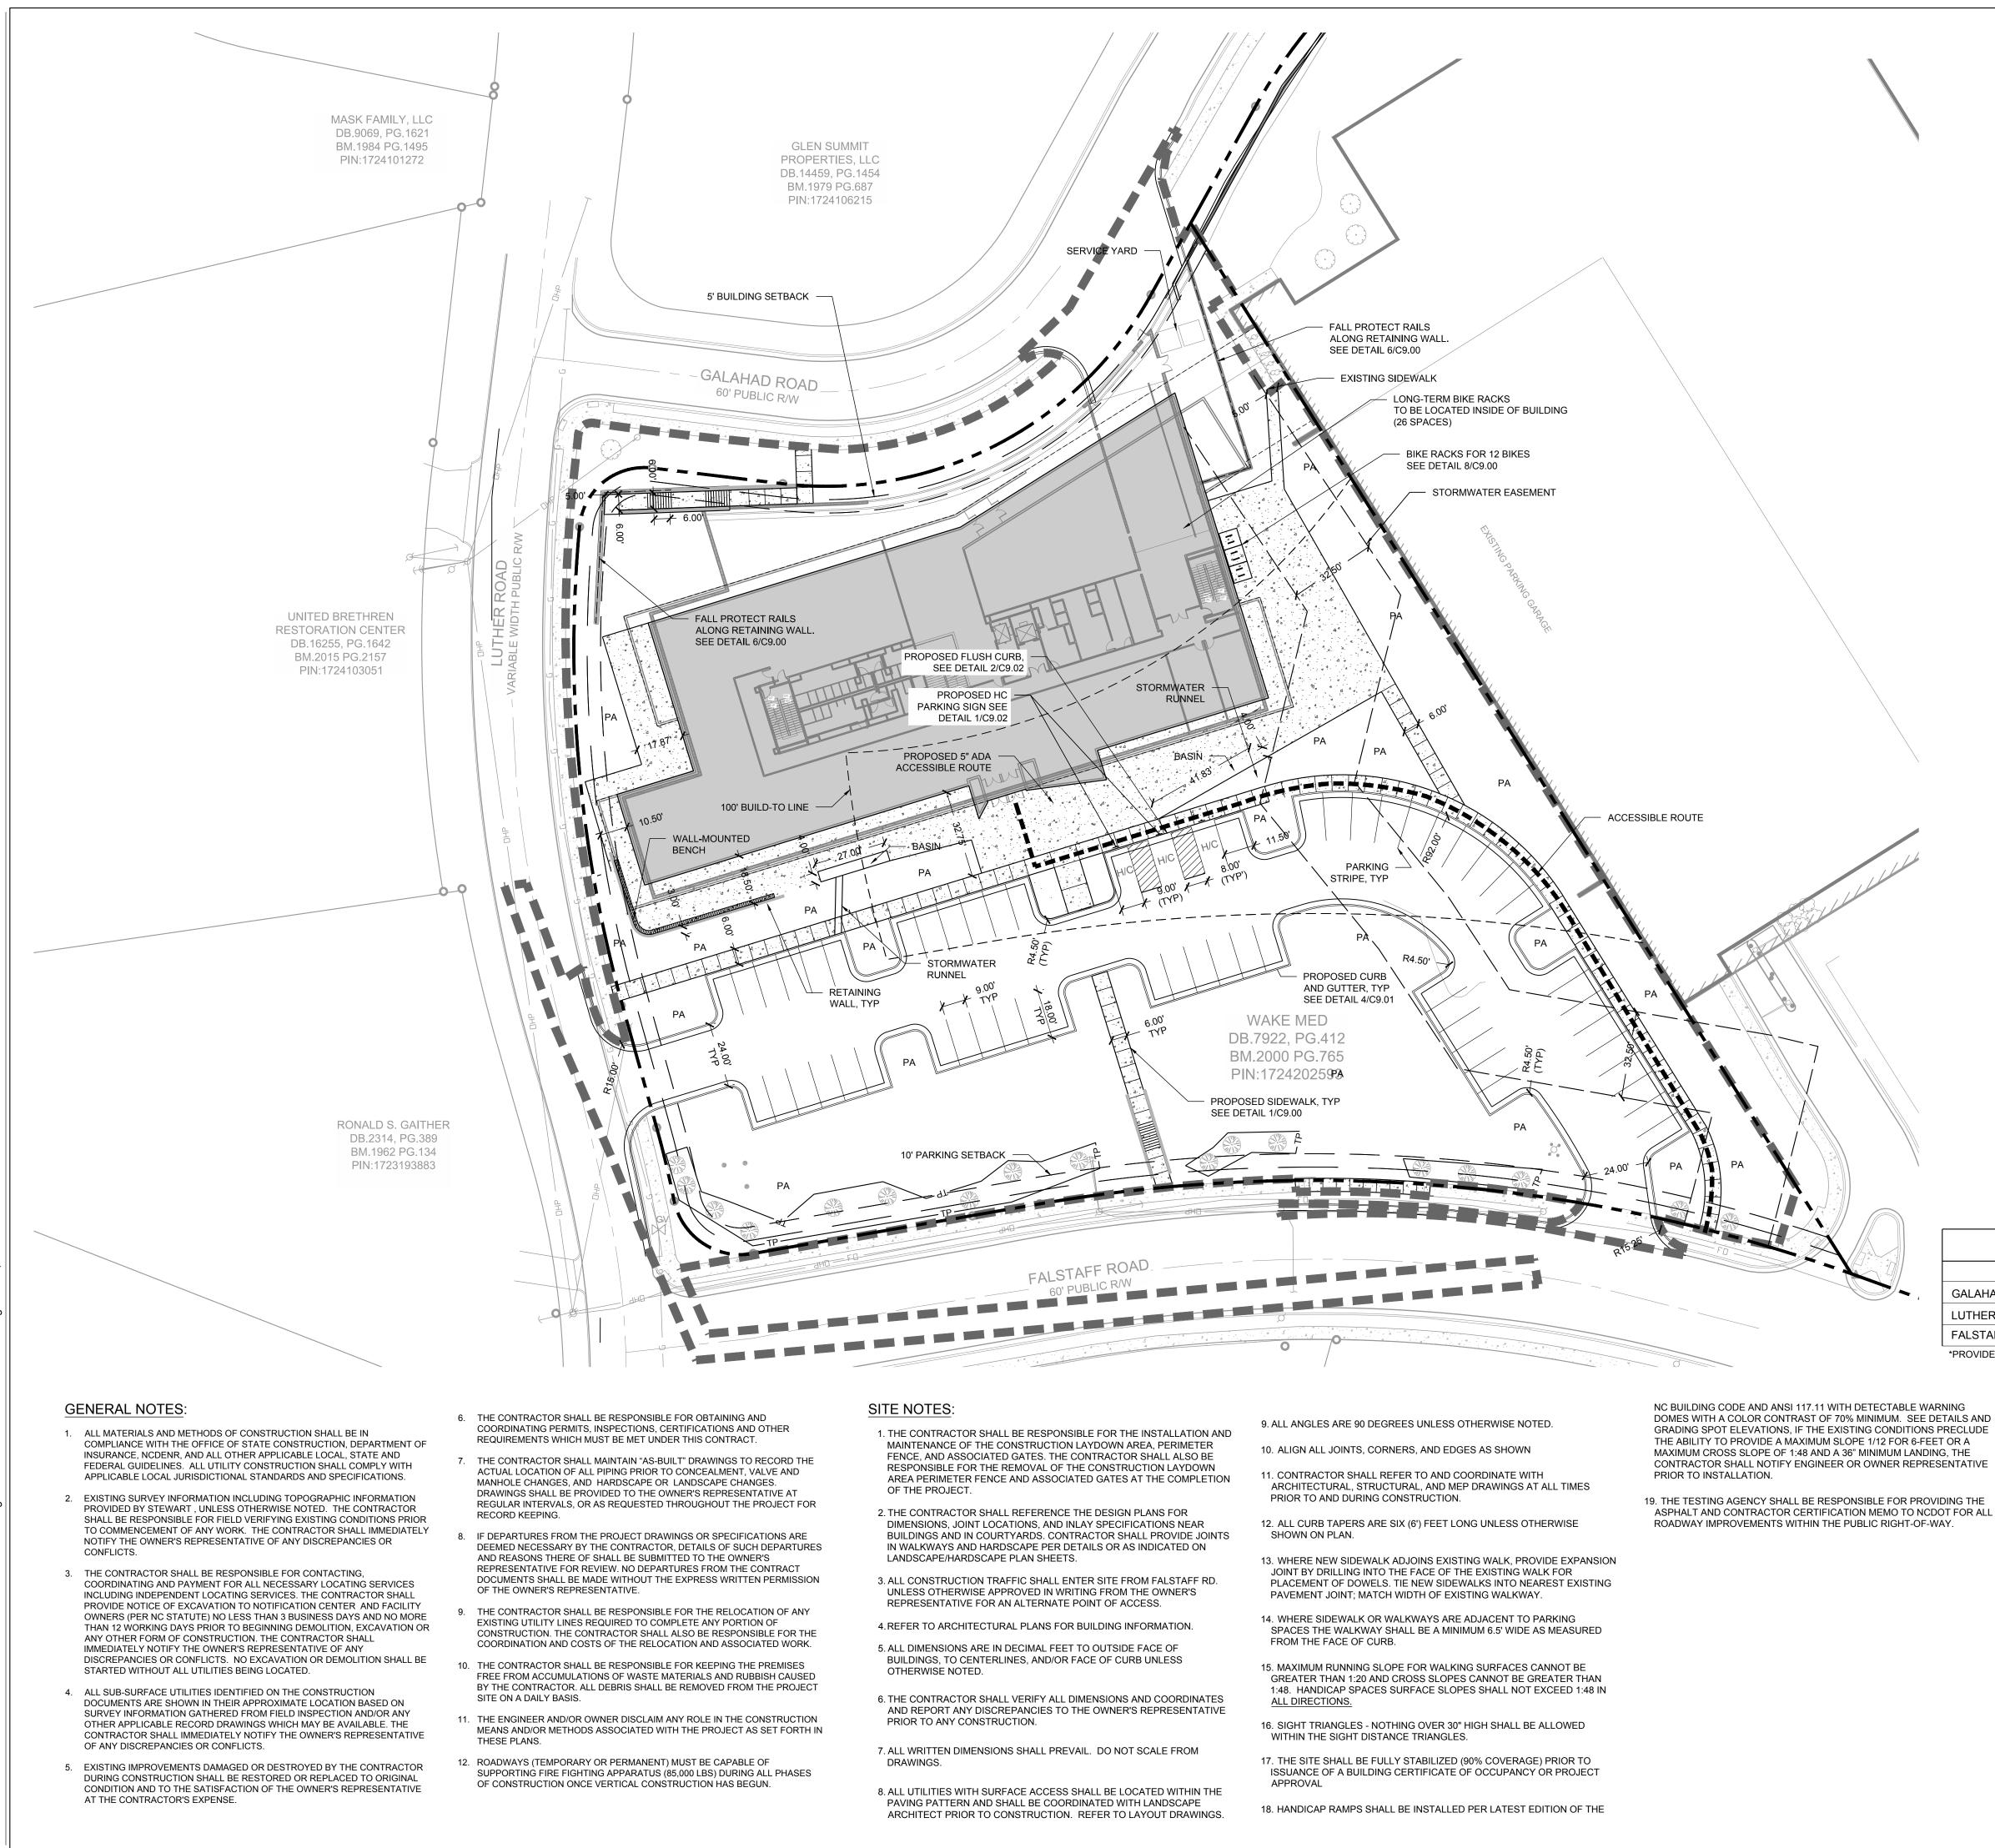

## SITE LEGEND

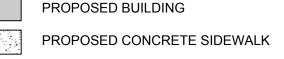

PROPOSED BRICK SIDEWALK

PROPOSED HEAVY DUTY PAVEMENT

PROPOSED CONCRETE PAVERS

PROPOSED GRAVEL

PROPOSED CURB & GUTTER PROPOSED STOP BAR

PROPOSED CROSSWALK

PROPOSED 6' WIDE STANDARD CROSSWALK

PROPOSED SIGN 0

H/C PROPOSED ADA PARKING SPACE

PROPOSED WHEEL STOP PROPOSED TREELINE 

□-● PROPOSED LIGHT PROPOSED TRANSFORMER PROPOSED BIKE RACK 

- PROPOSED BENCH
  - PROPOSED BOLLARD

LIMITS OF DISTURBANCE

## **BUILD-TO CALCULATIONS**

	REQUIRED %	% PROVIDED		
GALAHAD RD.	25%	88.50%		
LUTHER RD.	25%	28.53%		
FALSTAFF RD. (ASSUMED PRIMARY)	50%	92.23%*		

PROVIDED WITH AMENITY AREA PER UDO1.5.6 D

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WAKE MED 3000 NEW BERN AVE CARY, NC 27513 T: 350.8098
Project:
WAKE MED ADMINISTRATION FACILITIES
Vicinity map:
ALL BROOT BD.
THE SITE SHITTER AND
Sea
Issued for:
No.DateDescription12/23/2018Issued for ASR
0 15 30 60 NORTH SCALE: 1"=30'
Title:
SITE PLAN
Project number: C17117 Sheet: Date: 02.20.2018 Drawn by: TPG Approved by: JLW



- 8. ALL MANHOLES COVERS SHALL BE PAINTED TO LOCAL JURISDICTIONAL REQUIREMENTS.

## UTILITY LEGEND



— W — EXISTING WATER LINE PROPOSED FIRE HYDRANT PROPOSED WATER VALVE EXISTING SANITARY SEWER MANHOLE PROPOSED SANITARY SEWER MANHOLE

> PROPOSED CLEANOUT PROPOSED FDC

PROPOSED BACKFLOW METER

PROPOSED POST INDICATOR VALVE (PIV)

— — — 300' HYDRANT COVERAGE CIRCLE LIMITS OF DISTURBANCE

### WATER NOTES:

AS INDICATED, ALL WATERLINES SHALL BE DUCTILE IRON PIPE MEETING THE REQUIREMENTS OF ANSI-AWWA C151 PRESSURE CLASS 350 OR SOFT COPPER TYPE K PIPE PER ASTM B88. IF PVC WATERLINE IS INDICATED ON THE PLANS IT SHALL MEET THE REQUIREMENTS OF AWWA C-900; CLASS 200.

- 2. ALL WATERLINES SHALL HAVE A MINIMUM OF 3.5 FEET OF COVER.
- TESTING NOTES: PRESSURE: LEAKAGE SHALL NOT EXCEED THE MAXIMUM ALLOWABLE LEAKAGE SPECIFIED IN AWWA C 600. MINIMUM TEST PRESSURE SHALL BE 150 PSI FOR DOMESTIC AND 200 PSI FOR FIRE PROTECTION. BACTERIOLOGICAL: TWO SAMPLES FOR BACTERIOLOGICAL SAMPLING SHALL BE COLLECTED AT LEAST 24 HOURS APART. IF CONTAMINATION IS INDICATED, THEN THE DISINFECTION PROCEDURE AND TESTING SHALL BE REPEATED
- UNTIL SATISFACTORY RESULTS ARE OBTAINED. 4. THE CHLORINE IN HEAVILY CHLORINATED WATER FLUSHED FROM MAINS NEEDS TO BE NEUTRALIZED BEFORE DISCHARGE. CONTRACTORS SHALL NEUTRALIZE HEAVILY CHLORINATED WATER FLUSHED FROM MAINS PRIOR
- TO DISCHARGE OR TRANSPORT ALL HEAVILY CHLORINATED WATER OFFSITE FOR PROPER DISPOSAL. 5. PAINT VALVE COVERS, FIRE HYDRANTS AND OTHER WATER APPARATUS TO MEET THE LOCAL JURISDICTIONAL REQUIREMENTS.

## UTILITIES IMPROVEMENTS QTY

770 LF

46 LF

43 LF

Approved by:

PRIVATE SEWER	
8" PVC SEWER SERVICE	
PRIVATE WATER	
2" COPPER WATERLINE	
6" DIP WATERLINE	

STEWART
421 FAYETTEVILLE ST., SUITE 400 RALEIGH, NC 27601 T 919.380.8750 FIRM LICENSE #: C-1051 www.stewartinc.com PROJECT #: 17117
Client:
WAKE MED 3000 NEW BERN AVE CARY, NC 27513 T: 350.8098
Project:
WAKE MED ADMINISTRATION FACILITIES
Vicinity map:
NORTH
Issued for:
No. Doto Description
No.         Date         Description           1         2/23/2018         Issued for ASR
0 15 30 60 NORTH SCALE: 1"=30'
Title:
UTILITY PLAN
Project number: C17117 Sheet: Date: 02.20.2018 Drawn by: CJJ C6.00 Approved by: JWP



### LANDSCAPING NOTES:

- 1. DOES NOT MEET PRIMARY TCA
- 2. DOES NOT MEET SECONDARY 65' PERIMETER TCA BUFFER DIMENSIONS
- SECONDARY TCA FOR INDIVIDUAL 10" DIAMETER TREES WAS EVALUATED AS SHOWN ON THE PLAN. ALL EXISTING 10" DIAMETER AND LARGER TREES, EXCEPT FOR ONE, WERE FOUND TO HAVE A COMPROMISED CRZ.



TREES TO BE REMOVED TREES TO REMAIN

- 1. SEE SHEET C2.00 FOR DEMOLITION PLAN.
- 2. SEE SHEET C3.00 FOR GENERAL AND SITE NOTES.

Altered House21 FAYETTEVILLE ST., SUITE 400ALEIGH, NC 276017919.380.8750
Client: WAKE MED 3000 NEW BERN AVE CARY, NC 27513 T: 350.8098
Project: WAKE MED ADMINISTRATION FACILITIES
Vicinity map:       Vicinity map:         Vicinity map:       Vicinity map.         Vicinity map:       Vicinity map.         Vicinity map.       Vicinity map.         Vicinity map.
PRELIMINARY - DO NOT         USE FOR CONSTRUCTION         Issued for:         SITE PLAN         No.       Date         Description         1       2/23/2018         Issued for ASR
$ \begin{array}{c}  \\  \\  \\  \\  \\  \\  \\  \\  \\  \\  \\  \\  \\ $
TREE         CONSERVATION         PLAN         Project number: C17117         Sheet:         Date:       02.20.2018         Drawn by:       CJJ         Approved by:       JWP



TREE BUFFEF	REMARKS	<u>QTY</u>	<u>SIZE</u>	<u>CONT</u>	COMMON NAME	BOTANICAL NAME	<u>CODE</u>	<u>SHRUBS</u>	REMARKS
Street		113	N/A	3 Gal. Min.	Winterberry	llex verticallata	ILVE	$\odot$	
Falstaff Road (Existing Buffer to		53	N/A	3 Gal. Min.	Cleyera	Ternstroemia gynmanthera	TEGY	$\textcircled{\bullet}$	

### LANDSCAPING NOTES:

- 1. VERIFY ALL QUANTITIES AND REPORT ANY DISCREPANCIES OR INACCURACIES IN THE PLANS TO THE OWNER'S REPRESENTATIVE PRIOR TO PLANTING.
- 2. LANDSCAPE WORK SHALL INCLUDE THE FURNISHING, INSTALLATION, AND WARRANTY OF ALL PLANTING MATERIALS WITHIN THE PROJECT AREA.
- 3. THE LANDSCAPE CONTRACTOR SHALL ASCERTAIN THE LOCATION OF ALL EXISTING AND NEW UNDERGROUND UTILITIES PRIOR TO EXCAVATION FOR PLANTING. DAMAGES TO UTILITIES CAUSED BY THE LANDSCAPE OPERATION SHALL BE CORRECTED BY THE LANDSCAPE CONTRACTOR AT NO COST TO THE OWNER.
- 4. LANDSCAPING SHALL REMAIN CLEAR FROM ANY FIRE HYDRANTS ON THE SITE.
- 5. ALL TREES TO BE A MINIMUM OF 2" IN CALIPER AND MUST MEET THE AMERICAN STANDARD FOR NURSERY STOCK.
- 6. TREE PROTECTION NOTE: TREE PROTECTION FENCING MUST BE IN PLACE PRIOR TO ANY DEMOLITION, LAND DISTURBANCE OR ISSUANCE OF A GRADING PERMIT AND SHALL INCLUDE WARNING SIGNS POSTED IN BOTH ENGLISH AND SPANISH, AS FOLLOWS: "NO TRESPASSING/TREE PROTECTION AREA/PROHIBIDO ENTRAR / ZONA PROTECTORA PARA LOS ÁRBOLES."
- 7. PROTECTION OF EXISTING VEGETATION: AT THE START OF GRADING INVOLVING THE LOWERING OF EXISTING GRADE AROUND A TREE OR STRIPPING OF TOPSOIL, A CLEAN, SHARP, VERTICAL CUT SHALL BE MADE AT THE EDGE OF THE TREE SAVE AREA AT THE SAME TIME AS OTHER EROSION CONTROL MEASURES ARE INSTALLED. THE TREE PROTECTION FENCING SHALL BE INSTALLED ON THE SIDE OF THE CUT FARTHEST AWAY FROM THE TREE TRUNK AND SHALL REMAIN IN PLACE UNTIL ALL CONSTRUCTION IN THE VICINITY OF THE TREES IS COMPLETE. NO STORAGE OF MATERIALS, FILL, OR EQUIPMENT AND NO TRESPASSING SHALL BE ALLOWED WITHIN THE BOUNDARY OF THE PROTECTED AREA.
- 8. ROOT ZONE PROTECTION AREA: VARIES BASED ON LOCAL JURISDICTION HAVING AUTHORITY. CONTRACTOR SHALL COMPLY WITH LOCAL JURISDICTIONAL REQUIREMENTS. NO DISTURBANCE ALLOWED WITHIN THIS AREA. AREA MUST BE PROTECTED WITH BOTH TREE PROTECTION FENCING AND WARNING SIGNS.
- 9. SEED BED PREPARATION: ALL AREAS TO BE SEEDED ARE TO BE RECEIVE A MINIMUM OF 2" OF APPROVED TOPSOIL. ALL DEBRIS, ROCKS, ETC. LARGER THAN .5" ARE TO BE REMOVED. ALL LARGE CONCENTRATIONS OF GRAVEL & DEBRIS REGARDLESS OF SIZE ARE TO BE REMOVED PRIOR TO SEEDING OR PLANTING.
- 10. ALL PLANT BED AREAS ARE TO RECEIVE A MINIMUM OF 6" OF APPROVED TOPSOIL.
- 11. SOIL SHOULD BE TESTED AND AMENDED WITH LIME AND FERTILIZER FOR HARDWOOD TREES ACCORDING TO NCDA PROCEDURES. SCARIFY PLANT PIT WALLS. CONSULT LANDSCAPE ARCHITECT FOR ALTERNATE COMPLIANCE.
- 12. SHREDDED HARDWOOD MULCH 3" DEEP EXCEPT AT CROWN OF PLANT UNLESS OTHERWISE NOTED. FLARE AT CROWN SHOULD BE REVEALED. BACKFILL CONSISTS OF THOROUGHLY BROKEN UP NATIVE SOIL. TOTAL VOLUME OF BACKFILL SHOULD BE AMENDED WITH UP TO ONE THIRD PINE BARK MULCH. PIECES SHOULD BE NO LARGER THAN WHAT PASSES THROUGH A ONE INCH SCREEN. IF ADDITIONAL SOIL IS REQUIRED FOR BACKFILL DUE TO DETRIMENTAL SUBSOIL DRAINAGE CONDITIONS, USE SOIL SIMILAR TO EXISTING NATIVE SOIL. ADDITIONAL SOIL TO BE APPROVED BY LANDSCAPE ARCHITECT. MAXIMUM SAUCER HEIGHT IS 6 INCHES.
- 13. TOP OF ROOTBALL TO BE RAISED 2-3 INCHES ABOVE EXISTING GRADE.
- 14. FOR B&B PLANTS, NATURAL FIBER BURLAP SHOULD BE TURNED DOWN BY 1/3 TOTAL HEIGHT OF ROOT BALL. PLASTIC FIBER BURLAP AND WIRE BASKETS SHOULD BE REMOVED TO 2/3'S OF TOTAL HEIGHT OF ROOT BALL.
- 15. CONTRACTOR IS RESPONSIBLE FOR KEEPING THE TREE UPRIGHT AND PLUMB THROUGHOUT THE WARRANTY PERIOD. IF STABILIZATION IS NECESSARY SEE STAKING IN TREE DETAIL, ORANGE FLAGGING TAPE SHOULD BE ATTACHED TO SUPPORT WIRE. STAKING SHOULD BE REMOVED BY CONTRACTOR AT END OF ONE YEAR WARRANTY PERIOD OR AS DIRECTED BY GROUNDS MANAGEMENT.
- 16. USE STANDARD "GATOR" BAGS FOR WATERING TREES IN AREAS NOT UNDER IRRIGATION. INCORPORATE TERRA-SORB (OR EQUAL) AS PER MANUFACTURERS RECOMMENDATIONS, FOR AREAS NOT UNDER IRRIGATION.
- 17. USE "BIO-BARRIER" OR EQUIVALENT ACCORDING TO MANUFACTURER'S RECOMMENDATION FOR TREES THAT WILL BE PLANTED WITHIN 10' OF PAVEMENT
- 18. LANDSCAPING/C.O. STANDARDS NOTE: ALL LANDSCAPING MUST BE IN PLACE PRIOR TO REQUEST FOR A CERTIFICATE OF COMPLIANCE.

421 FAYETTEVILLE ST., SUITE 400 RALEIGH, NC 27601 T 919.380.8750
Client: WAKE MED 3000 NEW BERN AVE CARY, NC 27513 T: 350.8098
Project:
WAKE MED ADMINISTRATION FACILITIES
Vicinity map:
Issued for: SITE PLAN
No.         Date         Description           1         2/23/2018         Issued for ASR
0 15 30 60 NORTH SCALE: 1"=30'
PLANTING PLAN
Project number: C17117 Sheet: Date: 02.20.2018 Drawn by: TPG L1.00 Approved by: JLW


### ER CALCULATIONS\*


	Frontage	LF/SIZE	Spacing	Required Trees	Provided Trees
Remain**)	453'	425 LF ***	N/A	N/A	1
	344'	319 LF ****	40' O.C. Average	N/A	7
	282'	242 LF *****	35' O.C. Average	N/A	6
			TOTAL	N/A	14

### SURFACE PARKING PLANT CALCULATIONS

eq.	Amt. of Linear Feet	No. of Spaces	Required Plants	Provided Plants
10 Parking Spaces		61	12	14
Shrubs installed 30 per	498		150	166

\* Private Tree Buffer in lieu of street tree requirements \*\* Existing Buffer to remain in lieu of street tree or protective yard requirements \*\*\* 453 LF frontage minus 23 FT of driveway = 425 LF \*\*\*\* 344 LF frontage minus 25 FT of driveway = 319 LF \*\*\*\*\* 282 LF frontage minus 40 FT of driveway = 242 LF

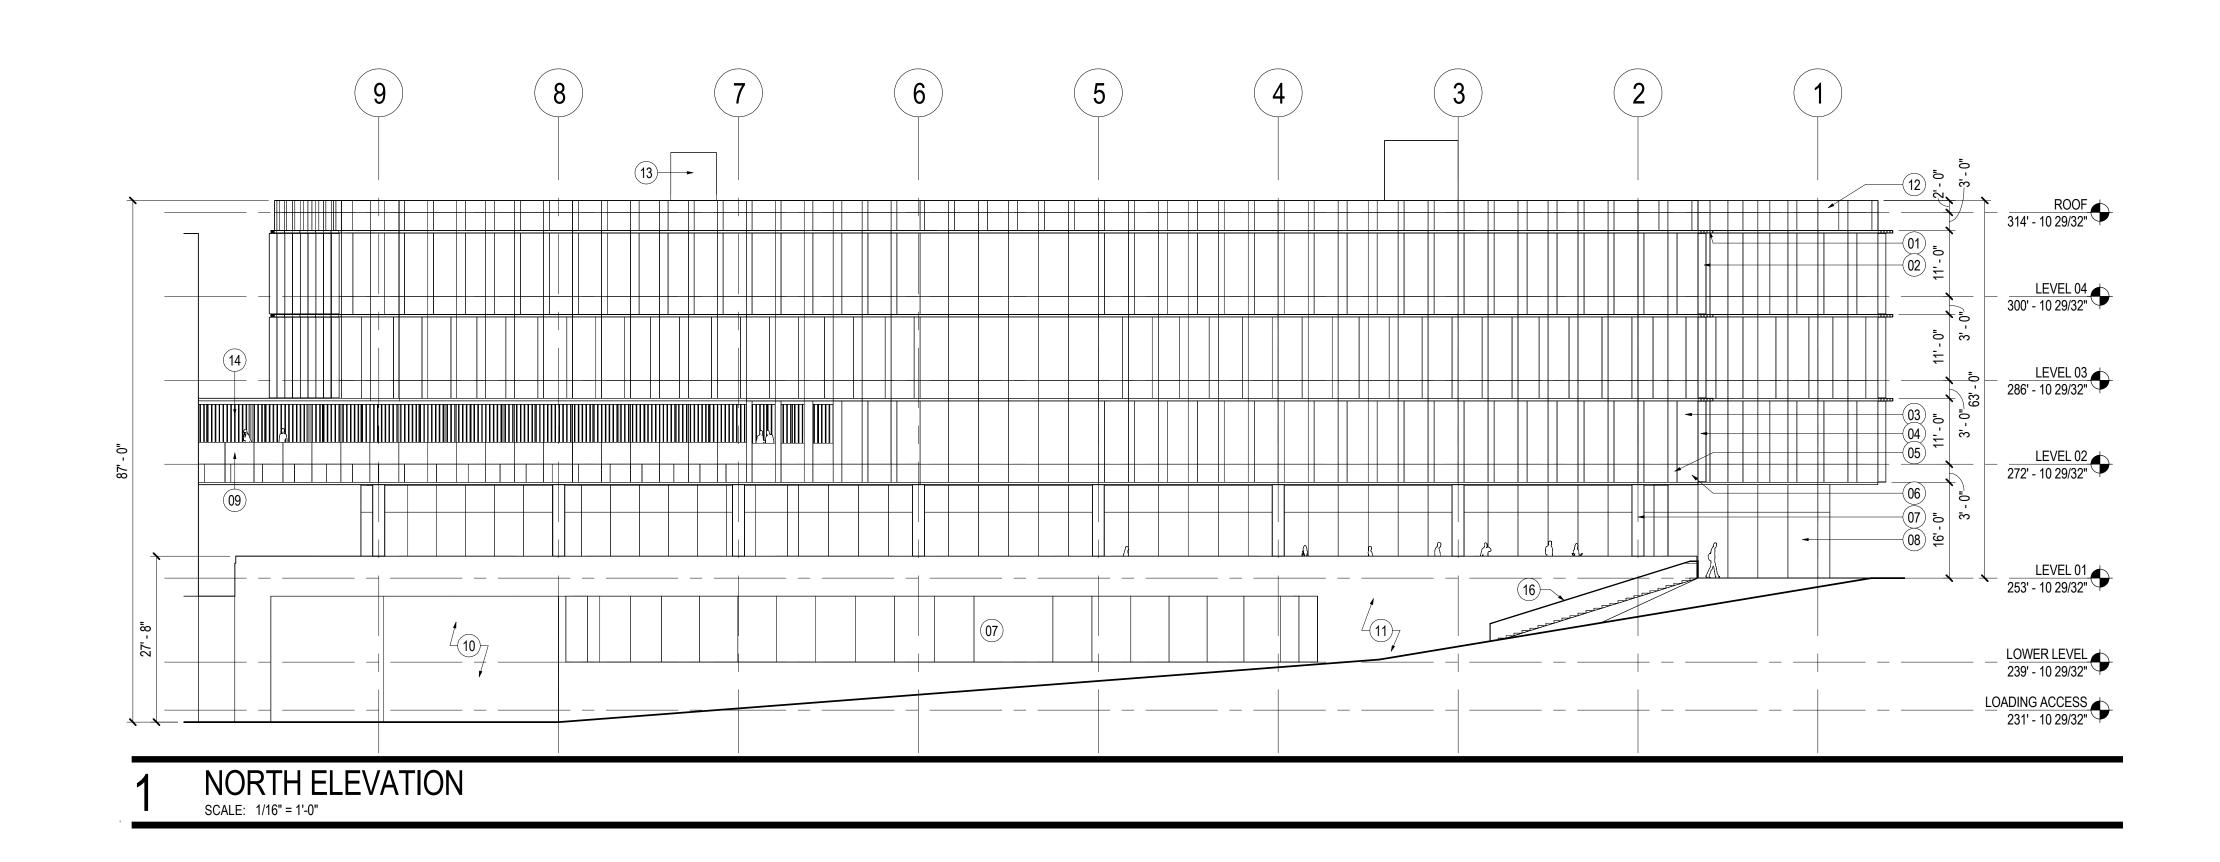


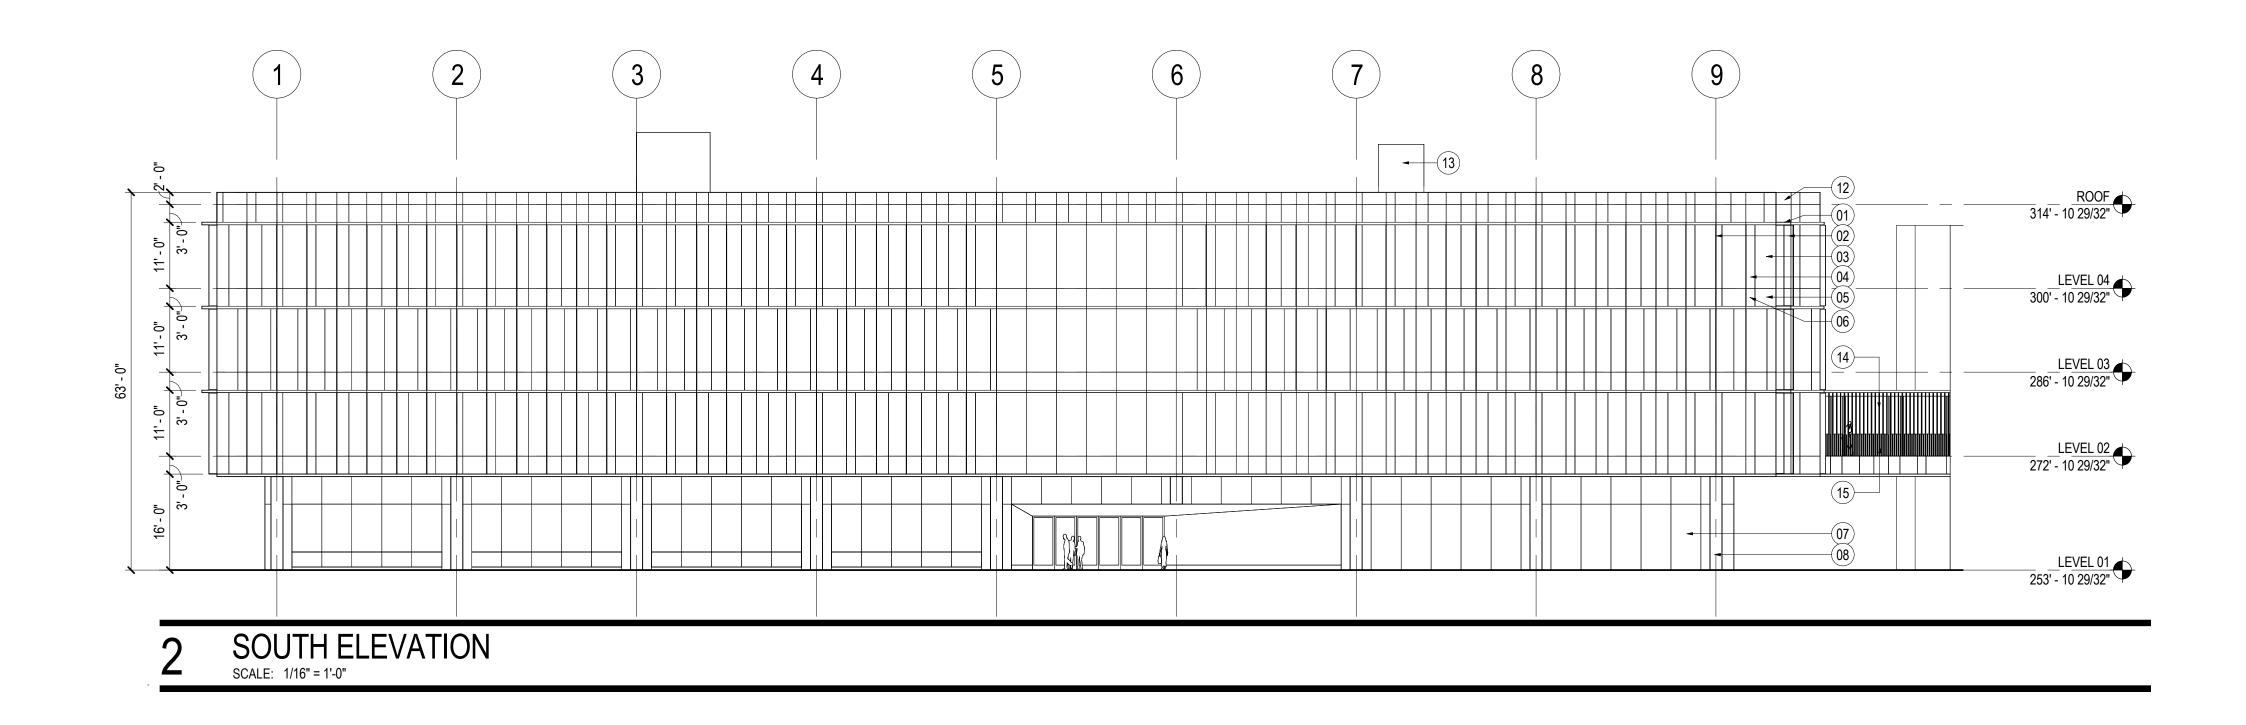




RALEIGH NC 2767	AVE 10-1231
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Suite 400 Raleigh, NC 27601 Tel 919.380.8750 Fax 919.380.8752	Cary, NC 27518 Tel 919.836.4800 Fax 919.836.4801
CRENSHAW, CONSULTING	
3516 Bush Street Suite 200 Raleigh, NC 27609 Tel 919.871.1070 Fax 919.871 5620	
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CONST Project Name WakeMed Act Building Project Number 90.0109.003 Description BUILDING ELEV	min Office
CONST Project Name WakeMed Ac Building Project Number 90.0109.003 Description	min Office
CONST Project Name WakeMed Act Building Project Number 90.0109.003 Description BUILDING ELEVA	min Office
	3000 NEW BERN A RALEIGH NC 2761 Geesle 530 Hillsborough St. Raleigh, NC 27603 United States

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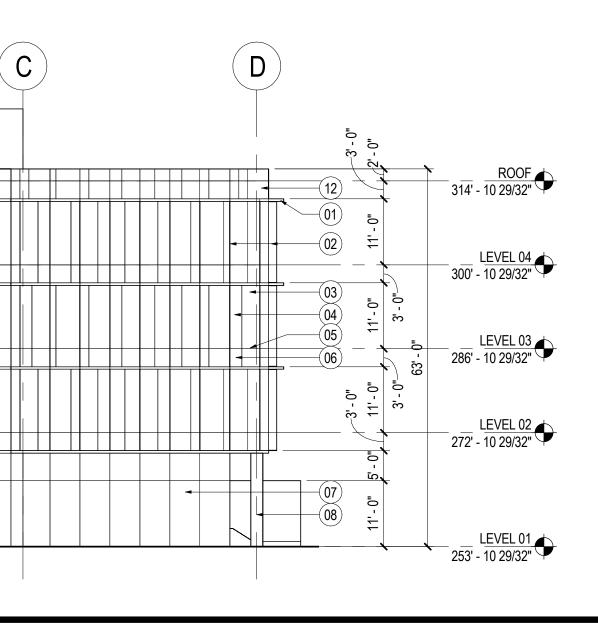
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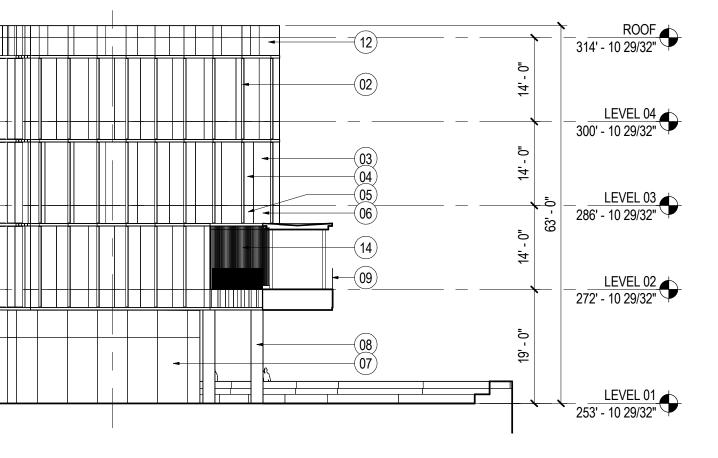


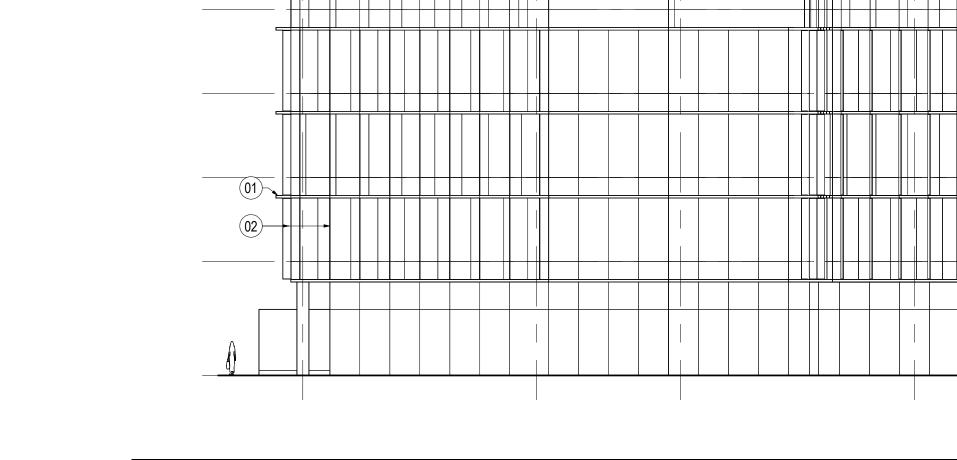
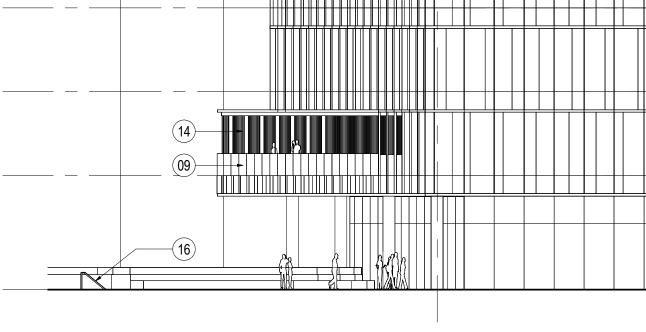
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## SHEET NOTES

- 01 SUNSHADE (42" PROJECTION)
- 02 10" ALUM FIN
- 03 VISION INSULATED GLAZING UNIT04 ACID ETCHED INSULATED GLAZING UNIT
- 04 ACID ETCHED INSULATED GLAZI 05 INSULATED SPANDREL IGU #1
- 06 INSULATED SPANDREL IGU #2
- 07 VISION INSULATED GLAZING UNIT IN CURTAIN WALL
- 08 RADIAL COLUMN ENCLOSURE ON 1-HR SPRAY FIREPROOFED STRUCTURAL COLUMN, TYP
   09 GLASS GUARDRAIL
- 10 OVERHEAD COILING DOOR
- 11 FACE BRICK WALL SYSTEM
- METAL PANEL WALL SYSTEM: METAL STUDS, 1/2" GYPSUM SHEATHING, 4" MINERAL WOOL INSULATION, PANEL FRAMING, METAL PANEL
   ENERGY RECOVERY VENTILATOR ON CURB
- 14 DECORATIVE SCREEN: PAINTED ALUMINUM PLATE ON CONC CURB
- 15 PAINTED STEEL BAR STOCK GUARD16 PAINTED STEEL RAILING

**GENERAL NOTES** 


RALEIGH NC 27610-1231

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△ Date Description

2/23/18 ISSUED FOR ADMIN SITE REVIEW

Seal / Signature

## NOT FOR CONSTRUCTION
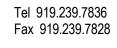
## Project Name

WakeMed Admin Office Building Project Number

90.0109.003

Description
BUILDING ELEVATIONS

Scale 1/16" = 1'-0"

A2.04

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**KEY PLAN**