

CERTIFICATE OF APPROPRIATENESS PLACARD

for Raleigh Historic Resources

15 E PEACE STREET

Address

BLOUNT STREET

Historic District

Historic Property

192-16-MW

Certificate Number

12-28-2016

Date of Issue

06-28-2017

Expiration Date

Project Description:

- Construct ADA access elevator on Belk Hall

This card must be kept pasted in a location within public view until all phases of the described project are complete. The work must conform with the code of the City of Raleigh and laws of the state of North Carolina. When your project is complete, you are required to ask for a final zoning inspection in a historic district area. Telephone the RHDC office at 832-7238 and commission staff will coordinate the inspection with the Inspections Department. If you do not call for this final inspection, your Certificate of Appropriateness is null and void.

Signature, 
Raleigh Historic Development Commission

Pending the resolution of appeals, commencement of work is at your own risk.

Raleigh Historic Development Commission – Certificate of Appropriateness (COA) Application



**DEVELOPMENT
SERVICES
DEPARTMENT**

Development Services
Customer Service Center
One Exchange Plaza
1 Exchange Plaza, Suite 400
Raleigh, North Carolina 27601
Phone 919-996-2495
eFax 919-996-1831



<input checked="" type="checkbox"/> Minor Work (staff review) – 1 copy <input type="checkbox"/> Major Work (COA Committee review) – 10 copies <input type="checkbox"/> Additions Greater than 25% of Building Square Footage <input type="checkbox"/> New Buildings <input type="checkbox"/> Demo of Contributing Historic Resource <input type="checkbox"/> All Other <input type="checkbox"/> Post Approval Re-review of Conditions of Approval	<p style="text-align: center; margin: 0;">For Office Use Only</p> <p>Transaction # <u>494603</u></p> <p>File # <u>192-16-MW</u></p> <p>Fee <u>\$2900</u></p> <p>Amount Paid <u>\$2900 CC</u></p> <p>Received Date <u>11-15-16</u></p> <p>Received By <u>GLW</u></p>
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Property Street Address **15 E. Peace Street** Raleigh, NC 27604

Historic District: **Blount Street Historic Overlay District**

Historic Property/Landmark name (if applicable) **Peace University**

Owner's Name **William Peace University**

Lot size	(width in feet)	(depth in feet)
----------	-----------------	-----------------

For applications that require review by the COA Committee (Major Work), provide addressed, stamped envelopes to owners of all properties within 100 feet (i.e. both sides, in front (across the street), and behind the property) not including the width of public streets or alleys ([Label Creator](#)).

Property Address	Property Address

I understand that all applications that require review by the commission's Certificate of Appropriateness Committee must be submitted by 4:00 p.m. on the application deadline; otherwise, consideration will be delayed until the following committee meeting. An incomplete application will not be accepted.

Type or print the following:

Applicant **MLB Construction Services, LLC**

Mailing Address **1930 N. Salem Street, Suite 201**

City **Apex**

State **NC**


Zip Code **27523**

Date **11/14/2016**

Daytime Phone **919-795-2768**

Email Address **jgallimore@mlbind.com**

Applicant Signature

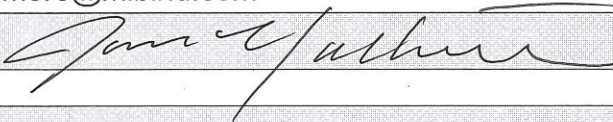

Will you be applying for rehabilitation tax credits for this project? Yes No

Did you consult with staff prior to filing the application? Yes No

Office Use Only

Type of Work _____

99 / 59

Design Guidelines - Please cite the applicable sections of the design guidelines (www.rhdc.org).

Section/Page	Topic	Brief Description of Work (attach additional sheets as needed)
2/7-16	Site and Setting	<p>MLB will be constructing/adding an elevator for ADA Access to this buildings existing second floor. The addition will be added to the exterior West Elevation of the Peace University Belk Hall Building. The new addition by adding the elevator will add 160sqft on the first floor and 100sqft on the second floor. All exterior finishes will match the existing facade on Belk Hall (brick masonry, boxing and fascia trim, doors and windows and exterior lighting. The new elevator construction will not exceed the existing roof ridge height. The existing walk and paver area adjacent to the West Elevation of Belk Hall will remain as is except for the area required to perform the minor addition of the elevator. A small ramp will address the gradient access to the new elevator entry meeting/giving ADA access. All disturbed pavers and paver walks will be reinstalled back adjacent to new construction with minimal impact to the existing conditions that exist along the West Elevation of Belk Hall.</p> <p>non-contributing</p>
2.5/17	Walkways	
3/25-35	Changes to the Bldg Exterior	
3/36-43	Exterior Walls, Windows, Doors and Entrances	
3.11/48-49	Accessibility, Health, and Safety Considerations: Guidelines	
4.2 /54	Additions to Historic Buildings	

alter ADA See also 160-13-MW

Minor Work Approval (office use only)

Upon being signed and dated below by the Planning Director or designee, this application becomes the Minor Work Certificate of Appropriateness. It is valid until 6/28/17. Please post the enclosed placard form of the certificate as indicated at the bottom of the card. Issuance of a Minor Work Certificate shall not relieve the applicant, contractor, tenant, or property owner from obtaining any other permit required by City Code or any law. Minor Works are subject to an appeals period of 30 days from the date of approval.

Signature (City of Raleigh) *[Handwritten Signature]* Date 12/28/16

	TO BE COMPLETED BY APPLICANT		TO BE COMPLETED BY CITY STAFF		
	YES	N/A	YES	NO	N/A
Attach 8-1/2" x 11" or 11" x 17" sheets with written descriptions and drawings, photographs, and other graphic information necessary to completely describe the project. Use the checklist below to be sure your application is complete. Minor Work (staff review) – 1 copy Major Work (COA Committee review) – 10 copies					
1. Written description. Describe clearly and in detail the nature of your project. Include exact dimensions for materials to be used (e.g. width of siding, window trim, etc.)	<input checked="" type="checkbox"/>				
2. Description of materials (Provide samples, if appropriate)	<input checked="" type="checkbox"/>				
3. Photographs of existing conditions are required. Minimum image size 4" x 6" as printed. Maximum 2 images per page.	<input checked="" type="checkbox"/>				
4. Paint Schedule (if applicable)	<input checked="" type="checkbox"/>	<input type="checkbox"/>			
5. Plot plan (if applicable). A plot plan showing relationship of buildings, additions, sidewalks, drives, trees, property lines, etc., must be provided if your project includes any addition, demolition, fences/walls, or other landscape work. Show accurate measurements. You may also use a copy of the survey you received when you bought your property. Revise the copy as needed to show existing conditions and your proposed work.	<input checked="" type="checkbox"/>	<input type="checkbox"/>			
6. Drawings showing existing and proposed work <input checked="" type="checkbox"/> Plan drawings <input checked="" type="checkbox"/> Elevation drawings showing the façade(s) <input checked="" type="checkbox"/> Dimensions shown on drawings and/or graphic scale (required) <input checked="" type="checkbox"/> 11" x 17" or 8-1/2" x 11" reductions of full-size drawings. If reduced size is so small as to be illegible, make 11" x 17" or 8-1/2" x 11" snap shots of individual drawings from the big sheet.	<input checked="" type="checkbox"/>	<input type="checkbox"/>			
7. Stamped envelopes addressed to all property owners within 100 feet of property not counting the width of public streets and alleys (required for Major Work). Use the Label Creator to determine the addresses.	<input type="checkbox"/>	<input checked="" type="checkbox"/>			
8. Fee (See Development Fee Schedule)	<input checked="" type="checkbox"/>				

WEST ELEVATION BELK HALL AREA FOR ELEVATOR



WEST ELEVATION BELK HALL INSIDE CORNER FOR NEW ELEVATION



WEST ELEVATION BELK HALL (NEW WORK WILL MATCH EXISTING FINISHES)



Elevator Addition

Belk Hall
William Peace University
15 East Peace Street
Raleigh, NC 27604

INDEX OF DRAWINGS

SHEET	DESCRIPTION
GENERAL	
G0.01	INDEX OF DRAWINGS, VICINITY MAP, EGRESS PLAN
G0.02	BUILDING CODE SUMMARY
G0.03	FIRE PROTECTION DETAILS & ACCESS, COMPLIANCE
G0.04	SPECIFICATIONS
G0.05	SPECIFICATIONS

SITE/CIVIL	DESCRIPTION
C-100	EXISTING CONDITIONS & SITE DEMO PLAN
C-200	SITE LAYOUT & SITE GRADING PLAN

ARCHITECTURAL	DESCRIPTION
A1.01	DEMOLITION PLANS
A2.01	NEWWORK PLANS & ROOF PLAN
A3.01	REFLECTED CEILING PLANS
A4.01	EXTERIOR ELEVATIONS
A5.01	WALL SECTIONS

STRUCTURAL	DESCRIPTION
S0.1	SPECIFICATIONS, INDEX
S0.2	SPECIFICATIONS
S0.3	ABBREVIATIONS, SYMBOLS
S1.1	FOUNDATION PLAN
S2.1	ROOF FRAMING PLAN
S2.2	HIGH ROOF FRAMING PLAN
S3.1	TYPICAL FOUNDATION DETAILS
S4.1	TYPICAL STEEL DETAILS
S5.1	TYPICAL FRAMING DETAILS
S5.2	TYPICAL ROOF FRAMING DETAILS
S5.3	ROOF FRAMING, DETAILS

MECHANICAL	DESCRIPTION
M0.01	MECHANICAL SCHEDULES, LEGEND & NOTES
M1.01	MECHANICAL PLAN & DETAILS

ELECTRICAL	DESCRIPTION
E0.01	ELECTRICAL SCHEDULES, DETAILS & NOTES
E1.01	ELECTRICAL LIGHTING AND POWER PLANS
E2.01	PANEL SCHEDULE & RISER


PLUMBING	DESCRIPTION
P0.01	PLUMBING SCHEDULES, DETAILS, & NOTES
P1.01	PLUMBING PLAN
P1.02	PLUMBING PLAN - RISERS

310ai


310 Architecture + Interiors, PA
P. O. BOX 97935
RALEIGH, NC 27624-7935
302 JEFFERSON STREET
SUITE 250
RALEIGH, NC 27605
PHONE (919) 838-9310
FAX (919) 838-9311
310ai.com
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PROGRESS SET
NOT FOR CONSTRUCTION


INDEX OF DRAWINGS 03
Scale: NTS

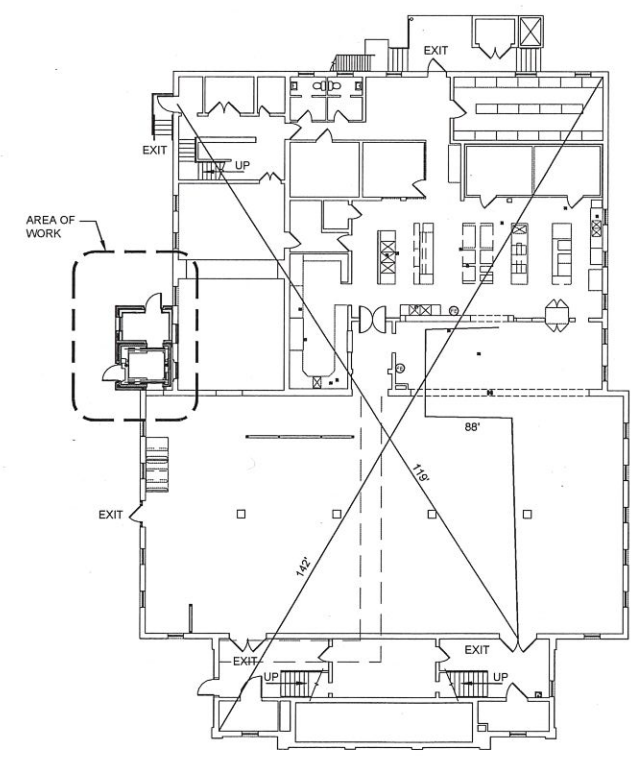

FIRST FLOOR EGRESS PLAN 04
Scale: 1/16" = 1'-0"

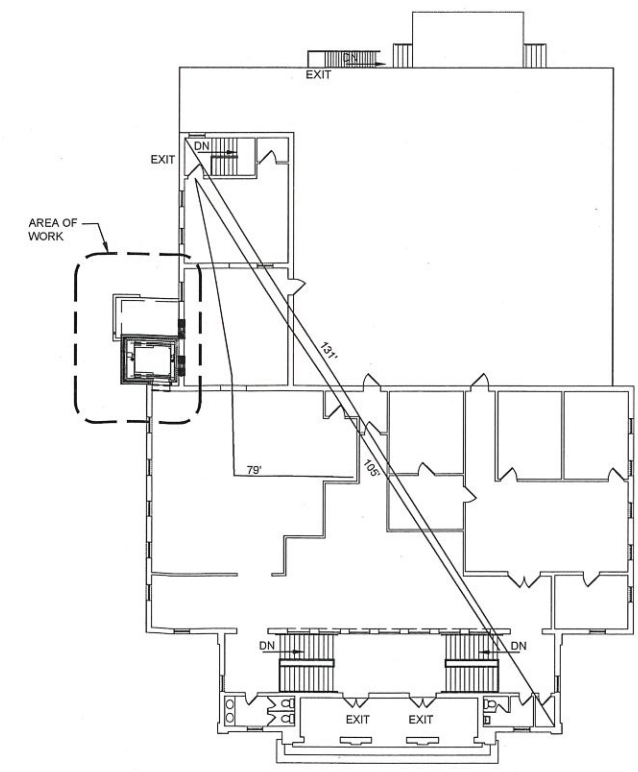

SECOND FLOOR EGRESS PLAN 03
Scale: 1/16" = 1'-0"

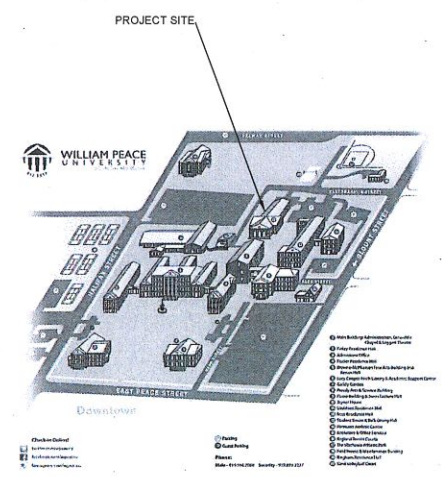


VICINITY MAP 01
Scale: NTS

Elevator Addition
Belk Hall, William Peace University
15 East Peace Street
Raleigh, NC 27604


PROJECT #	16054	
DATE:	11.11.2016	
DRAWN BY:	WBS	
CHECKED BY:	DBB, WBS	
NO.	REVISION	DATE

Index of Drawings
Vicinity Map
Egress Plan

G0.01

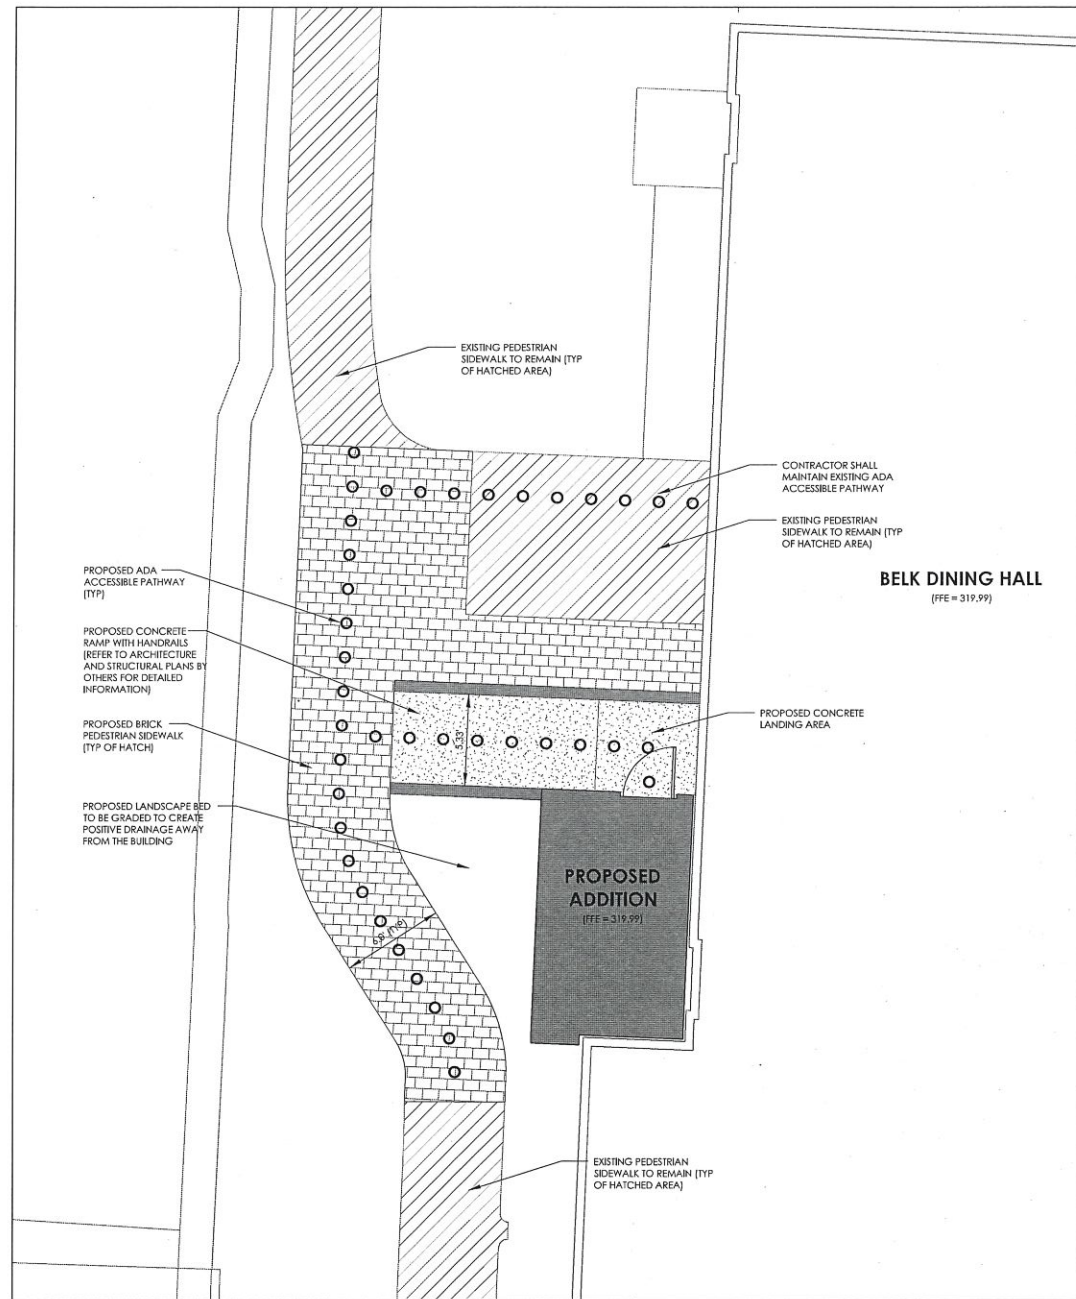

SITE LAYOUT PLAN

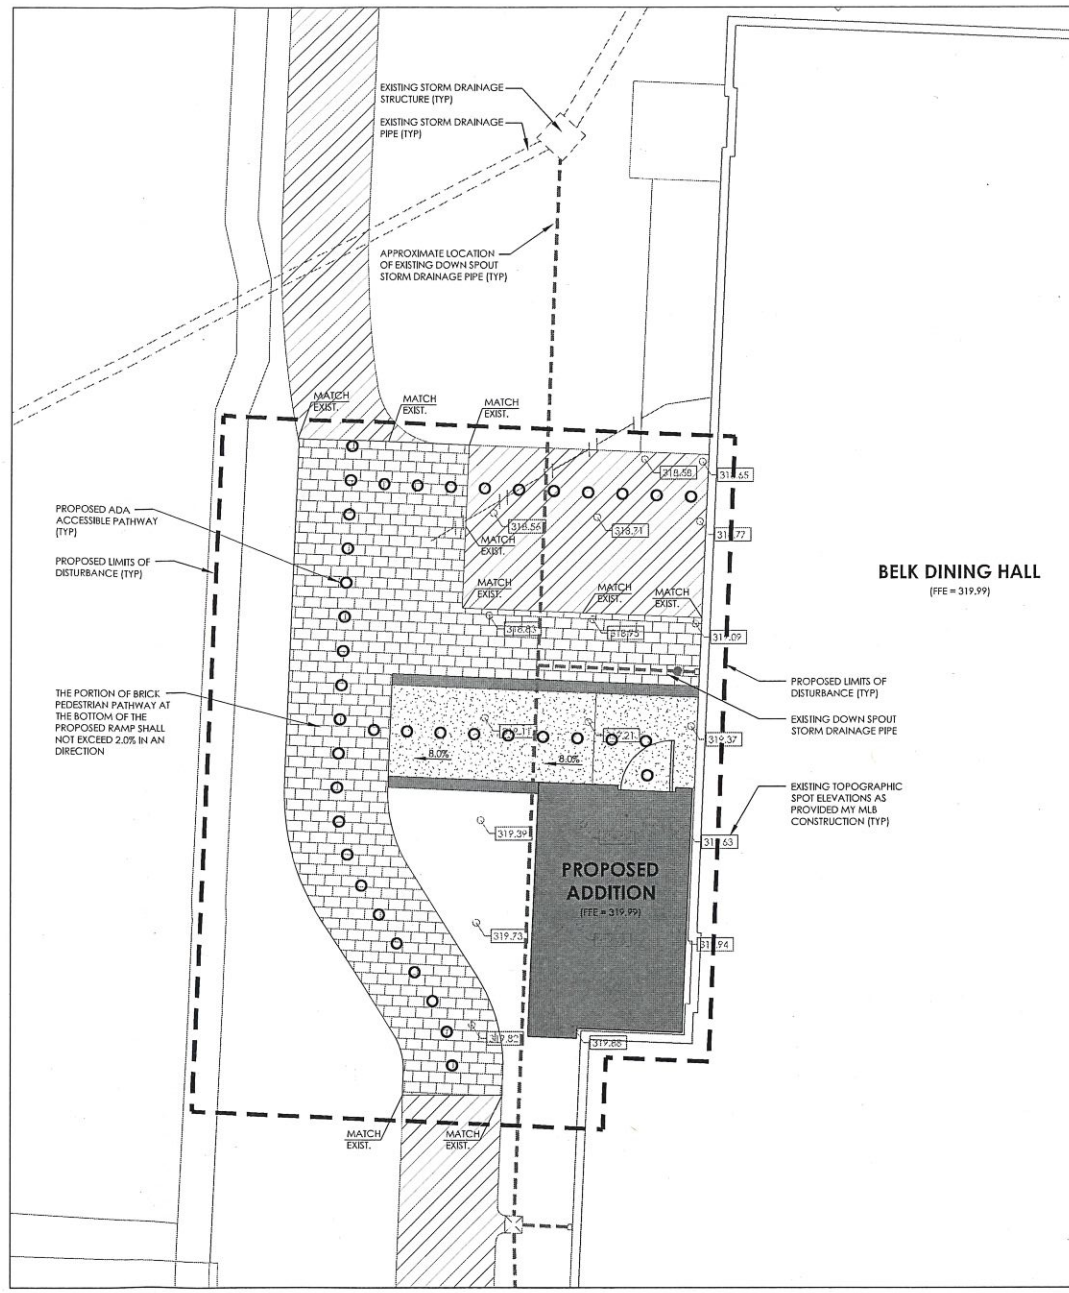


SITE GRADING PLAN

ALL CONSTRUCTION SHALL CONFORM WITH CITY OF RALEIGH STANDARDS AND SPECIFICATIONS.
REFER TO SHEET C-100 FOR GENERAL NOTES.

LEGEND

---XXX---	EXISTING CONTOUR (MAJOR)
---XXX---	EXISTING CONTOUR (MINOR)
---	EXISTING WATERLINE
SS---	EXISTING SANITARY SEWER
T---	EXISTING TELEPHONE UTILITY LINE
G---	EXISTING GAS UTILITY LINE
E---	EXISTING ELECTRICAL UTILITY LINE
OU---	EXISTING OVERHEAD UTILITY LINE
FO---	EXISTING FIBER OPTIC UTILITY LINE
---	EXISTING UNKNOWN UTILITY LINE
---	EXISTING STORM DRAINAGE
☆	EXISTING LIGHT/UTILITY POLE
⊕	EXISTING FIRE HYDRANT
⊙	EXISTING SANITARY SEWER MANHOLE
⊠	EXISTING STORM DRAINAGE STRUCTURE
⊞	EXISTING WATERLINE VALVE
⊗	EXISTING TREE
~	EXISTING TREELINE
---	PROPOSED LIMITS OF DISTURBANCE
[Brick Pattern]	PROPOSED BRICK PAVEMENT WALKWAY
[Concrete Pattern]	PROPOSED CONCRETE WALKWAY
○ ○ ○ ○ ○	PROPOSED ADA ACCESSIBLE PATHWAY
XXX.XX	EXISTING TOPOGRAPHY SPOT ELEVATION

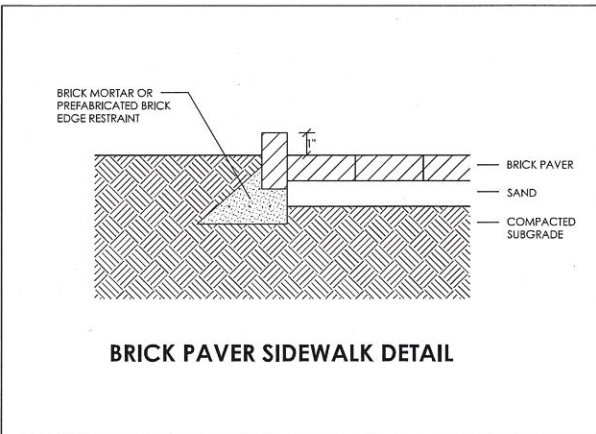

BRICK PAVER SIDEWALK DETAIL

SITE LAYOUT NOTES

- REFER TO GENERAL NOTES.
- BUILDING SIZE, DIMENSIONS, AND LOCATION ARE APPROXIMATE AND ARE PROVIDED FOR DIAGRAMATIC PURPOSES ONLY. REFER TO ARCHITECTURAL PLANS BY OTHERS FOR DETAILED INFORMATION INCLUDING DIMENSIONS, LOCATION, AND BUILDING FOOTPRINT.
- THE CONTRACTOR SHALL PROVIDE CONSTRUCTION JOINTS FOR ALL CONCRETE SIDEWALK AND CONCRETE PAVING IN ACCORDANCE WITH GUIDELINES PROVIDED BY THE PORTLAND CEMENT ASSOCIATION AND THE AMERICAN CONCRETE INSTITUTE.
- THE MINIMUM CORNER CLEARANCE FROM CURB LINE OF INTERSECTION STREETS SHALL BE AT LEAST TWENTY (20) FEET FROM THE POINT OF TANGENCY.
- WITHIN THE SIGHT DISTANCE TRIANGLES SHOWN ON THIS PLAN, NO OBSTRUCTION SHALL BE INSTALLED BETWEEN TWO (2) FEET AND EIGHT (8) FEET IN HEIGHT ABOVE THE CURB LINE ELEVATION OR THE NEAREST TRAVEL WAY, IF NO CURBING EXISTS.
- ALL SIDEWALKS MUST BE ACCESSIBLE TO PERSONS WHO ARE BLIND, HAVE LOW VISION, AND PEOPLE WITH MOBILITY DISABILITIES. ALTERNATE PEDESTRIAN ROUTES DURING CONSTRUCTION WILL BE REQUIRED TO BE COMPLIANT WITH THE PUBLIC RIGHTS-OF-WAY ACCESSIBILITY GUIDELINES (PRAWG), 2010 ADA STANDARDS FOR ACCESSIBLE DESIGN, AND THE MANUAL ON UNIFORM TRAFFIC CONTROL DEVICES (MUTCD).
- ALL SIDEWALKS ON SITE SHALL HAVE A CROSS SLOPE LESS THAN 2.0%.
- THIS PROJECT WILL PROVIDE TRASH COLLECTION ACCOMMODATIONS IN AN EXISTING TRASH COLLECTION FACILITY ON CAMPUS.

SITE UTILITY NOTE

- THERE ARE NO PROPOSED SITE UTILITY IMPROVEMENTS RELATED TO SANITARY SEWER AND WATER FOR THIS PROJECT. THE EXISTING WATER AND SANITARY SEWER SERVICES WILL REMAIN IN PLACE TO SERVICE THE SUBJECT BUILDING.

GRADING & DRAINAGE NOTES

- REFER TO GENERAL NOTES.
- COMPACTION OF SOILS SHALL BE PERFORMED IN ACCORDANCE WITH CITY OF RALEIGH STANDARDS AND SPECIFICATIONS AND/OR RECOMMENDATIONS OF A LICENSED GEOTECHNICAL ENGINEER.
- THE CONTRACTOR SHALL CONTACT GROUNDED ENGINEERING FOR ANY VARYING SITE CONDITIONS OR DISCREPANCIES AFFECTING SITE ACCESSIBILITY REQUIREMENTS.
- SLOPES THAT ARE 3:1 OR FLATTER ARE PERMITTED TO BE SEEDED. SLOPES STEEPER THAN 3:1 ARE REQUIRED TO BE SOODED. 1:1 SLOPES ARE NOT PERMITTED UNLESS ADJACENT TO A RETAINING WALL. 1:1 SLOPES ARE NOT ALLOWED WITHIN ANY PUBLIC EASEMENT.
- THE CONTRACTOR SHALL BE RESPONSIBLE FOR CONSTRUCTING AND GRADING ALL PROPOSED IMPROVEMENTS IN A MANNER THAT ALLOWS FOR POSITIVE DRAINAGE AWAY FROM THE BUILDING. PONDING WATER ANYWHERE ON SITE IS PROHIBITED.
- NO STATEMENT IS MADE OR IMPLIED THAT THE ON-SITE GRADING AND EARTHWORK INDICATED ON THESE DRAWINGS IS BALANCED.
- NO STATEMENT IS MADE OR IMPLIED REGARDING THE QUALITY OF THE ON-SITE SOILS.

SITE ACCESSIBILITY NOTES

ALL BUILDINGS WITHIN THE BOUNDARY OF THIS SITE, UNLESS OTHERWISE NOTED AS EXEMPT, SHALL HAVE "ACCESSIBLE ROUTES" AS REQUIRED TO COMPLY WITH THE REQUIREMENTS OF THE AMERICANS WITH DISABILITIES ACT, FAIR HOUSING STANDARDS, AND GOVERNING STATE HANDICAP CODE STANDARDS. THESE STANDARDS FOR ACCESSIBILITY INCLUDE, BUT ARE NOT LIMITED TO:

- MAXIMUM WALK SLOPE = 1:20
- MAXIMUM RAMP SLOPE = 1:12 WITH RAILING
- MAXIMUM CROSS SLOPE = 1/4" PER FOOT (2%)
- ALL WALKS TO BE BROOM FINISHED CONCRETE UNLESS OTHERWISE SPECIFIED ON THESE DRAWINGS

PROPOSED AREA OF DISTURBANCE

THE PROPOSED LIMITS OF DISTURBANCE FOR THIS PROJECT AS SHOWN ON THESE PLANS IS APPROXIMATELY 1,250 SF.

EROSION CONTROL PERMIT EXEMPTION

THE PROPOSED LIMITS OF DISTURBANCE FOR THIS PROJECT AS SHOWN ON THESE PLANS IS APPROXIMATELY 1,250 SF. PER THE CITY OF RALEIGH UDO, AN EROSION CONTROL PLAN AND PERMIT ARE NOT REQUIRED FOR LAND DISTURBING ACTIVITIES LESS THAN 12,000 SF.

STORMWATER MANAGEMENT EXEMPTION


THE PROPOSED SITE AS SHOWN HAS BEEN CALCULATED TO RESULT IN A NET INCREASE OF 36 SF OF IMPERVIOUS AREA. A PREVIOUS PROJECT ENTITLED "BELK HALL RENOVATIONS - WILLIAM PEACE UNIVERSITY" RECORDED A NET DECREASE OF 442 SF THAT COULD BE USED ON FUTURE PROJECTS. BY USING 36 SF OF THE PREVIOUSLY BANKED IMPERVIOUS AREA FOR THIS SITE, THE PROJECT WILL COMPLY WITH CITY OF RALEIGH UDO SECTION 9.2.2.4. INDICATING THAT THE SUBSTITUTION OF IMPERVIOUS AREAS ARE EXEMPT FROM STORMWATER MANAGEMENT REQUIREMENTS. THE REMAINING BALANCE AVAILABLE FOR USE WITH FUTURE PROJECTS ON THIS PARCEL IS NOW 306 SF.

GROUND COVER NOTES

- STABILIZE DIVERSION DITCHES INTENDED TO BE IN SERVICE FOR 30 DAYS OR MORE WITH TEMPORARY SEEDING AND EROSION CONTROL NETTING.
- FOR ALL AREAS OF MODERATE AND/OR STEEP SLOPES, PROVIDE TEMPORARY GROUND COVER IF THE SLOPE HAS NOT BEEN DISTURBED FOR A PERIOD OF FOURTEEN (14) CALENDAR DAYS.
- PROVIDE GROUND COVER SUFFICIENT TO RESTRAIN EROSION ON ANY PORTION OF THE SITE UPON WHICH FURTHER LAND DISTURBING ACTIVITY IS NOT BEING UNDERTAKEN WITHIN FOURTEEN (14) CALENDAR DAYS OR TEMPORARILY OR PERMANENTLY SUSPENDING LAND DISTURBING ACTIVITY.
- ESTABLISH PERMANENT GROUND COVER SUFFICIENT TO RESTRAIN EROSION WITHIN FOURTEEN (14) CALENDAR DAYS FOLLOWING COMPLETION OF CONSTRUCTION OR DEVELOPMENT AND/OR PRIOR TO FINAL INSPECTION.

4079 Utes Road
Raleigh, NC 27606
919.438.3694 (o)
919.438.3694 (f)
Firm License C-3898

grounded
ENGINEERING

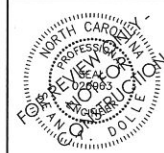


BELK DINING HALL ADDITION
AT WILLIAM PEACE UNIVERSITY


SITE LAYOUT & SITE GRADING PLAN



ISSUE DATE	11/07/2016	0 - INITIAL SUBMITTAL TO CITY OF RALEIGH
PROJECT #	16018	1 - REV. PER CONTRACTOR COMMENTS
SHEET #	C-200	

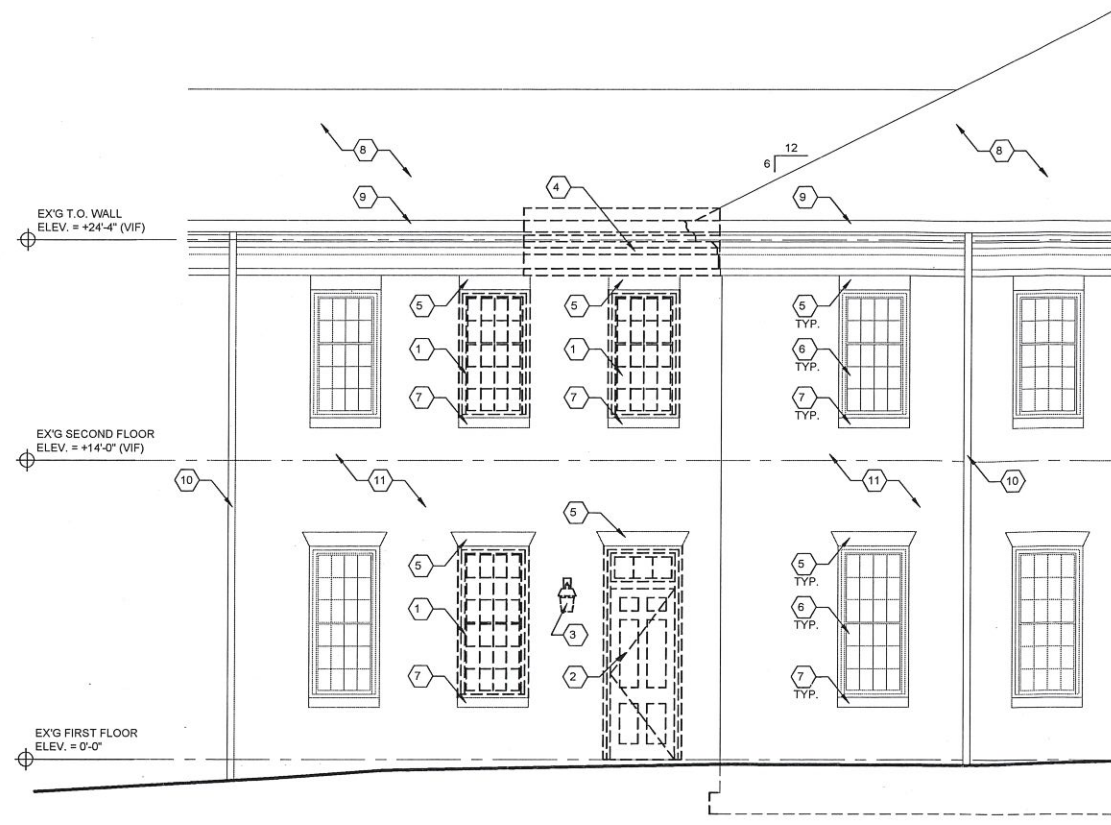

DEMOLITION EXTERIOR ELEV. - WEST 06
Scale: 1/4" = 1'-0"

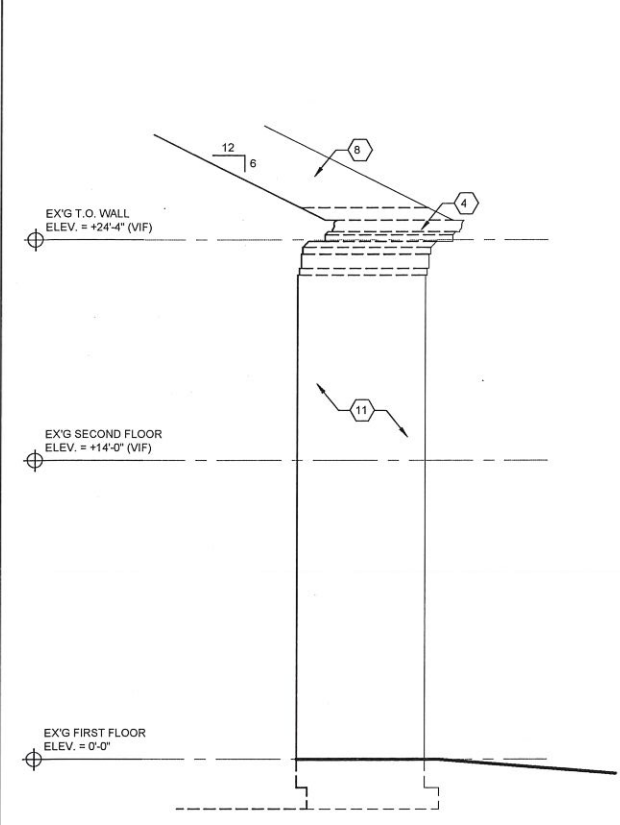


DEMOLITION EXTERIOR ELEV. - NORTH 05
Scale: 1/4" = 1'-0"


GENERAL ELEVATION DEMOLITION NOTES:
1. REFER TO GENERAL DEMOLITION NOTES ON SHEET A1.01.

- ELEVATION DEMOLITION KEYNOTES:**
- 1 DEMOLISH EX'G WINDOW
 - 2 DEMOLISH EX'G DOOR
 - 3 SALVAGE EX'G LIGHT FIXTURE FOR REUSE. REFER TO ELEC. DRAWINGS
 - 4 DEMOLISH PORTION OF ROOF, GUTTER AND EAVE AS REQ'D FOR NEW WORK. REFER TO PLANS AND SECTIONS FOR MORE INFO.
 - 5 EX'G CAST STONE LINTEL TO REMAIN
 - 6 EX'G WOOD WINDOW TO REMAIN
 - 7 EX'G CAST STONE SILL TO REMAIN
 - 8 EX'G ASPHALT SHINGLES TO REMAIN
 - 9 EX'G GUTTER AND EAVE ASSEMBLY TO REMAIN
 - 10 EX'G DOWNSPOUT TO REMAIN
 - 11 EX'G 4" FACE BRICK TO REMAIN

DEMOLITION ELEVATION NOTES 04
Scale: -

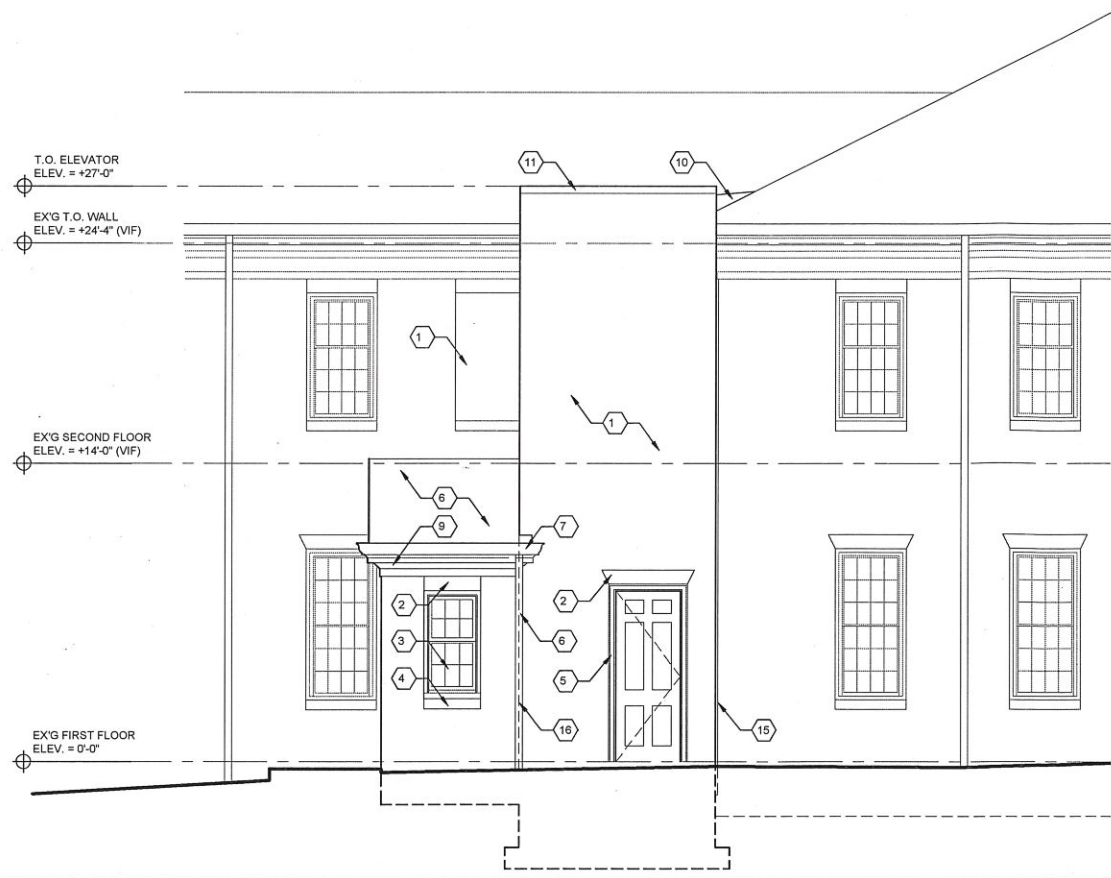

NEW WORK EXTERIOR ELEV. - WEST 03
Scale: 1/4" = 1'-0"

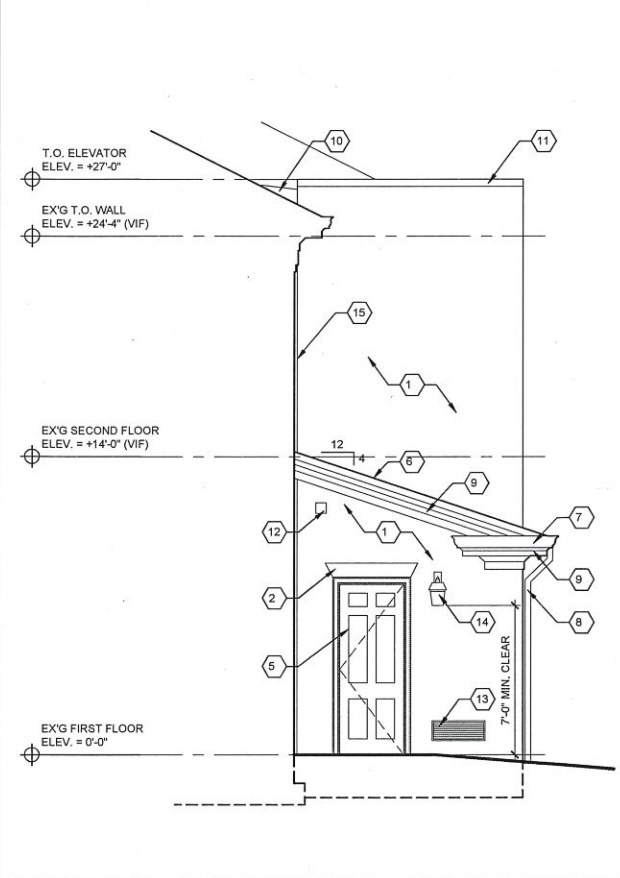

NEW WORK EXTERIOR ELEV. - NORTH 02
Scale: 1/4" = 1'-0"

GENERAL ELEVATION NEW WORK NOTES:
1. VERIFY LAYOUT OF COMPONENTS PRIOR TO COMMENCING CONSTRUCTION.
2. COLORS AND FINISHES OF EXTERIOR MATERIALS TO BE AS SELECTED AND APPROVED BY ARCHITECT.

- ELEVATION NEW WORK KEYNOTES:**
- 1 4" FACE BRICK TO MATCH EX'G
 - 2 CAST STONE CONCRETE LINTEL (PAINTED)
 - 3 DOUBLE HUNG WOOD WINDOW
 - 4 CAST STONE CONCRETE SILL (PAINTED)
 - 5 PANEL DOOR
 - 6 ASPHALT SHINGLES TO MATCH EX'G
 - 7 6" X 6" ALUM. GUTTER
 - 8 3" X 4" ALUM. DOWNSPOUT
 - 9 WOOD TRIM (PAINTED)
 - 10 E.P.D.M. ROOF CRICKET
 - 11 COPING BY ELEVATOR MFGR.
 - 12 GABLE VENT PER MECH. DRAWINGS
 - 13 P.T.A.C. UNIT PER MECH. DRAWINGS
 - 14 WALL SCONCE LIGHT PER ELEC. DRAWINGS
 - 15 EXPANSION JOINT COVER
 - 16 BRICK EXPANSION JOINT

NEW WORK ELEVATION NOTES 01
Scale: -

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RALEIGH, NC 27605
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FAX (919) 838-9311
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PROGRESS SET
NOT FOR CONSTRUCTION


Elevator Addition
Belk Hall, William Peace University
15 East Peace Street
Raleigh, NC 27604

PROJECT #	16054	
DATE:	11.11.2016	
DRAWN BY:	RMC	
CHECKED BY:	DBB, WBS	
NO.	REVISION	DATE

Exterior Elevations


A4.01

PROGRESS SET
NOT FOR CONSTRUCTION

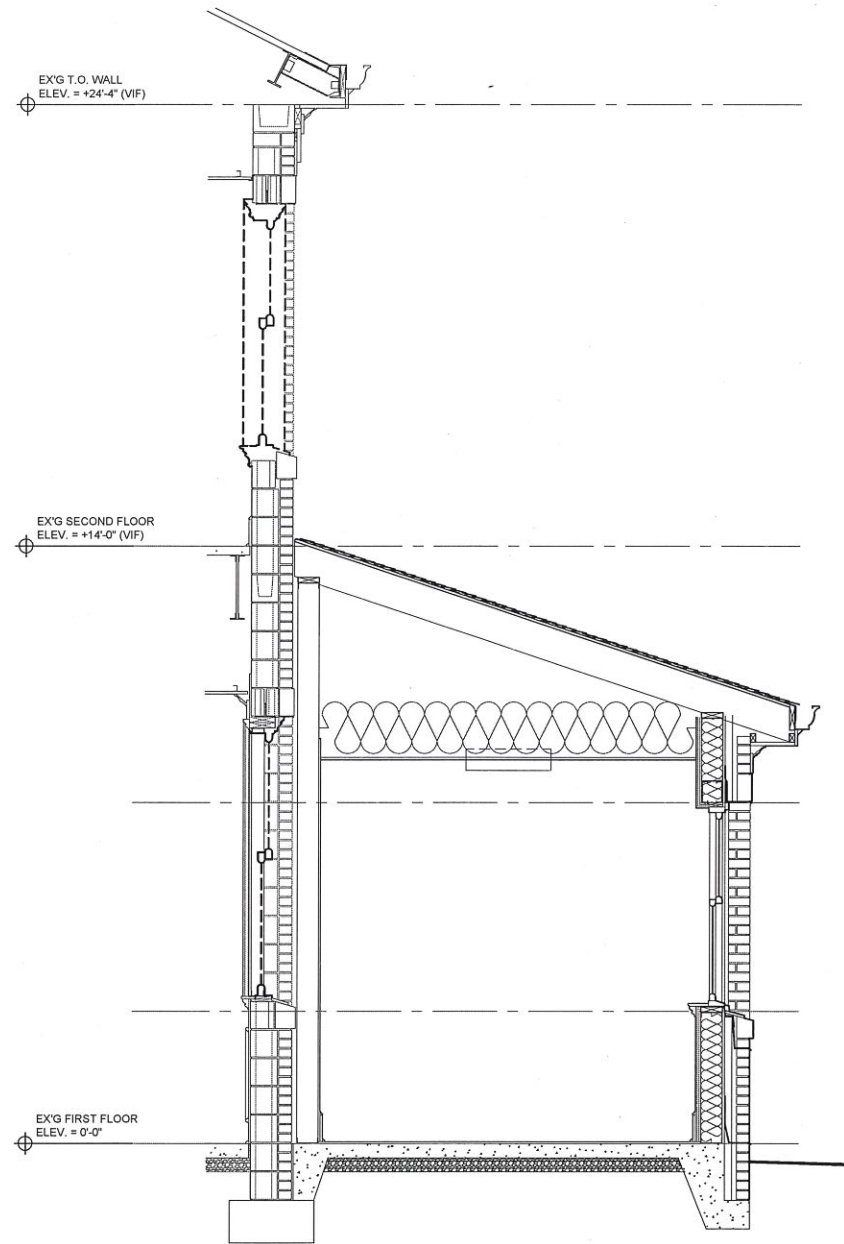


NEW WORK WALL SECTION 03

Scale: 1/2" = 1'-0"

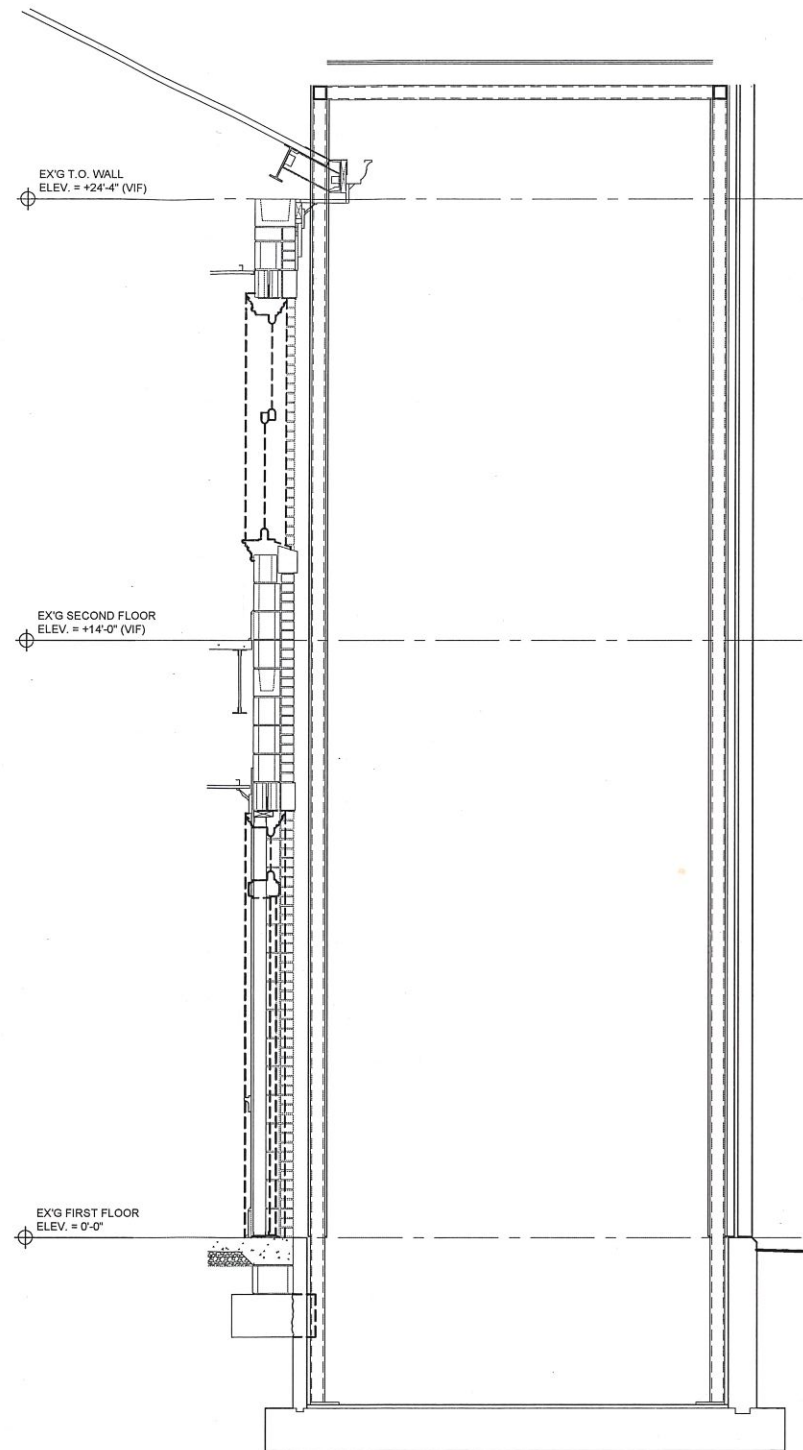

NEW WORK WALL SECTION 02

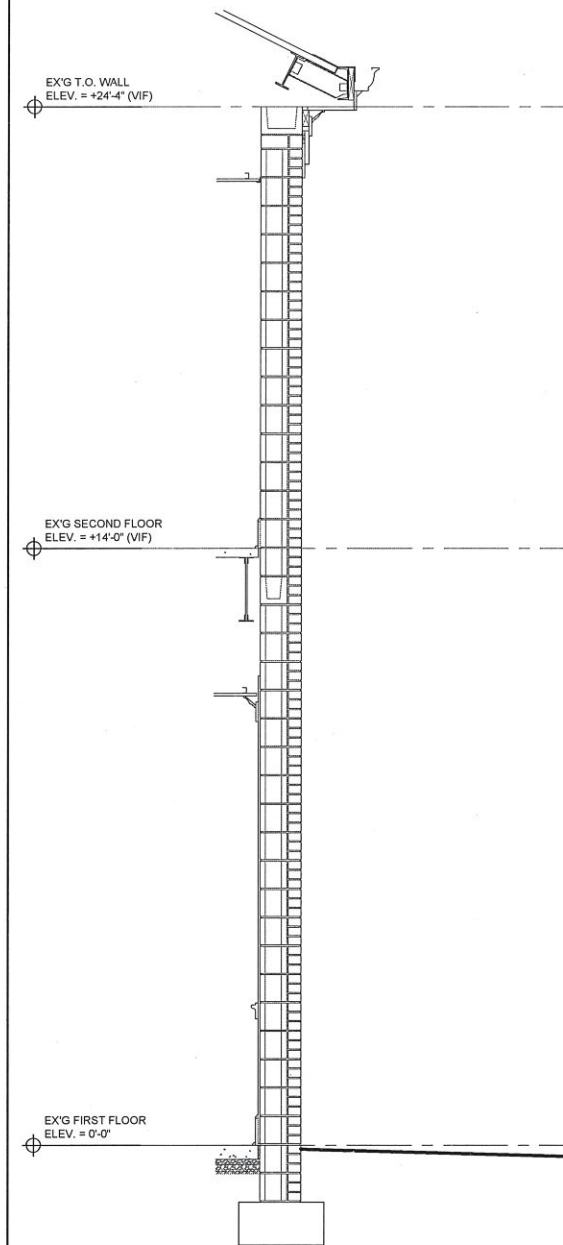

DEMOLITION WALL SECTION 01

Elevator Addition

Belk Hall, William Peace University
15 East Peace Street
Raleigh, NC 27604

PROJECT #	16054	
DATE:	11.11.2016	
DRAWN BY:	RMC	
CHECKED BY:	DBB, WBS	
NO.	REVISION	DATE


Wall Sections

A5.01

PROGRESS SET
NOT FOR CONSTRUCTION

Elevator Addition

Belk Hall, William Peace University
15 East Peace Street
Raleigh, NC 27604

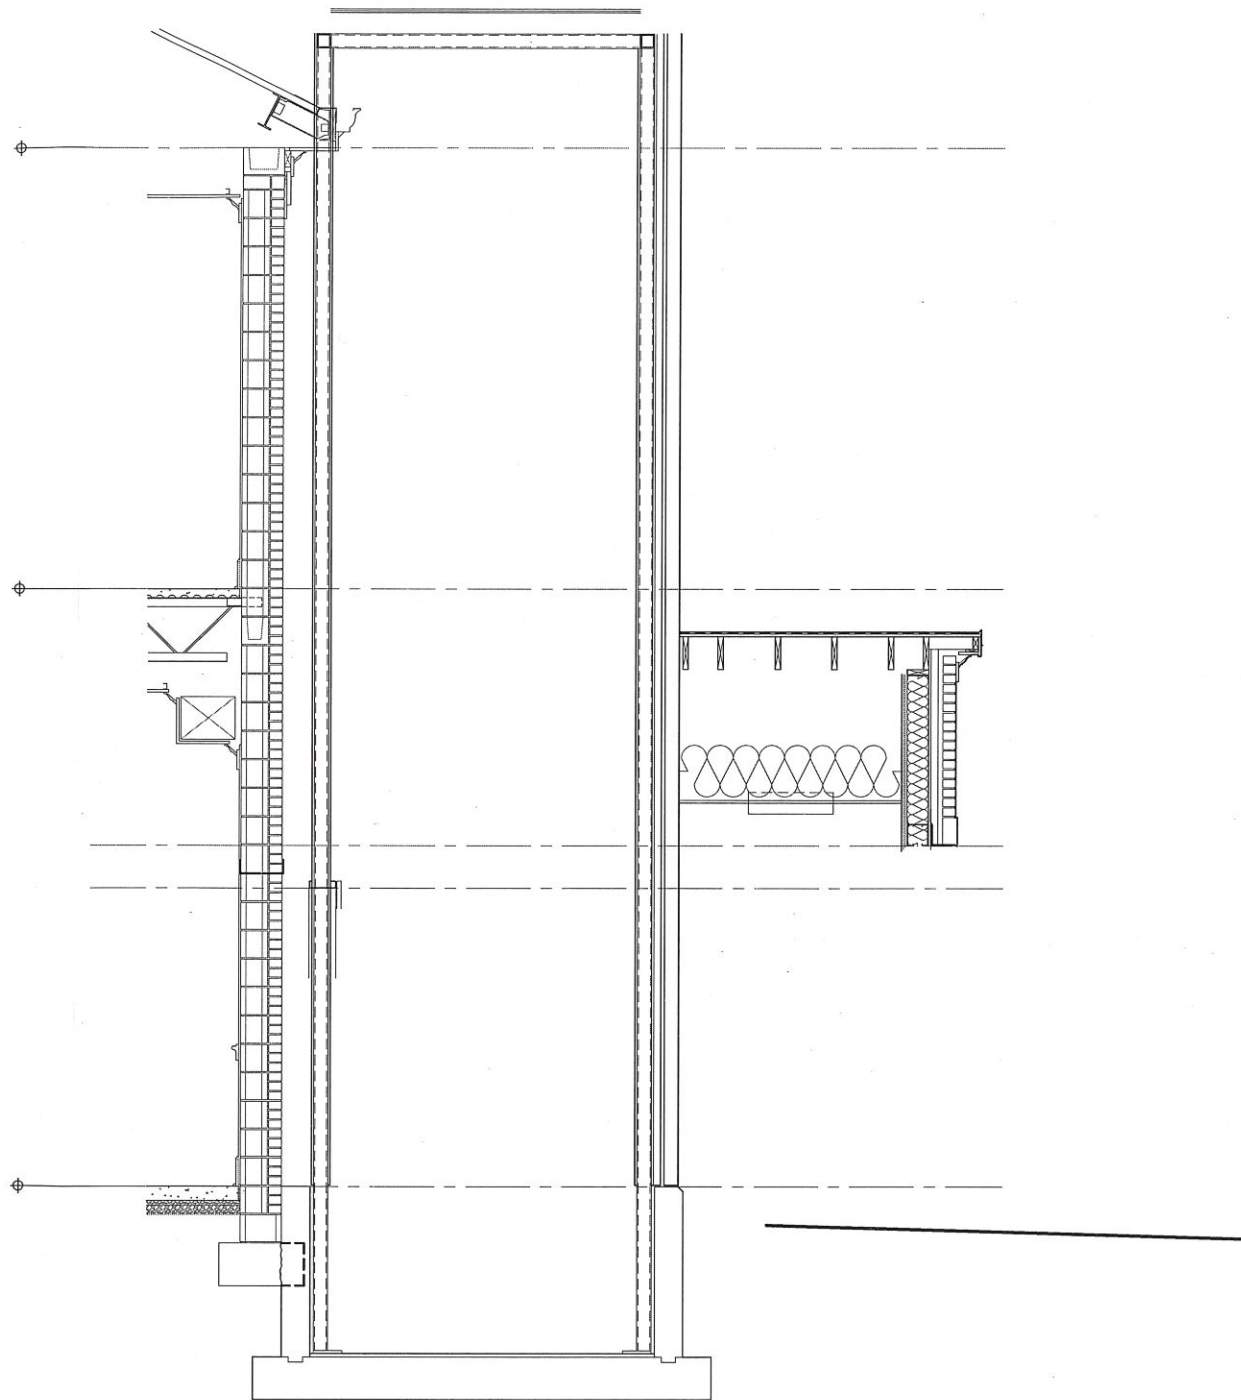

WALL SECTION 02
Scale: 1/2" = 1'-0"

WALL SECTION 01
Scale: 1/2" = 1'-0"

PROJECT #	16054	
DATE:	11.11.2016	
DRAWN BY:	RMC	
CHECKED BY:	DBB, WBS	
NO.	REVISION	DATE

Wall Sections

A5.02