

September 24, 2010

Mr. Allen Sherrill Triangle Broadcast Associates, LLC 3012 Highwoods Boulevard – Suite 201 Raleigh, NC 27604-1031

Re: Special Use Permit SU-5-10 -

Proposed Relocation and Replacement of Radio Transmission Tower

Dear Mr. Sherrill:

In its meeting held on September 7, 2010 the Raleigh City Council approved the application submitted by Curtis Media group for a Special Use Permit to relocate and replace the existing 280-foot high radio transmission tower located at 649 Maywood Avenue and owned by Triangle Broadcast Associates, LLC.

Please contact the City of Raleigh Planning Department (516-2626) and Inspections Department (516-2495) to determine the steps necessary to proceed. If you have any questions concerning the Council's action, please do not hesitate to call me at 996-3040.

Sincerely,

Leslie H. Eldredge, CMC

Deputy City Clerk

Enclosure

c: Planning – Jaque Baker Inspections – Larry Strickland

IN RE: Telecommunication Tower, Curtis Media Group

On August 3, 2010, the Raleigh City Council held a hearing to receive evidence in the matter of Telecommunication Tower, Curtis Media Group a request to be issued a special use permit. The request is to relocate and replace the existing radio transmission tower which is 280 feet in height, located at 649 Maywood Avenue and owned by Triangle Broadcast Associates, LLC. The subject property is 6.06 aces in size and zoned Industrial-2 with Special Highway Overlay District-2. The applicant wishes to replace the existing tower with a new tower of the same height approximately 67.80 feet from thee existing tower. The existing tower will be removed after the new tower has been constructed. As a result of that hearing and the testimony and other evidence received there the City Council makes the following findings of fact and conclusions of law.

FINDINGS OF FACT

- 1. All parties necessary to the determination of this request were properly notified and were or had the opportunity to be represented at the hearing.
- 2. Raleigh City Code §10-2145 requires the following conditions be satisfied before an special use permit may be issued.
- a. As will be established by expert testimony at the hearing of this matter, the New Tower will not disturb or diminish radio or television or similar reception for adjoining properties.
- b. The height of the New Tower will be 280 feet, which does not exceed 510 feet.
- c. The lightning of the New Tower will not exceed the minimum standards of the Federal Aviation Administration for a red obstruction lightning system as contained in Advisory Circular No. N70/7460-IF dated September 27, 1978, as amended.
 - d. With regard to minimum yard setback,
 - 1. The yard setback exceeds the minimum of 20 feet on the north, west, and south boundaries of Parcel. Such boundaries adjoin or are across a public street from lots zoned Industrial-2 District, a non-residential district, and that are either vacant or developed without a dwelling, congregate care, or congregate living structure.

- 2. The yard setback from the outside dimensions of the New Tower to Parcel PIN 1703-21-2634, which is to the east of the Parcel and is zoned Residential -10 CUD, is 222 feet This distance is less than the 280 foot height of the New Tower, but grounds exist to support a determination by the City Council that the yard setback of 222 feet will not be injurious to property or improvements in the affected area. The reduction in setback will have very little, if any, impact upon the visibility of the Tower from the parcel zoned R-10 CUD. Further, at the hearing of this matter, engineering evidence will show that in the event of a collapse of the New Tower, no portion of the New Tower would fall outside the boundaries of the Parcel.
- e. As shown on the Site Plan, the base of the New Tower and each guy anchor is surrounded by a fence at least eight feet in height. Except for their entrances, all fences upon the Parcel will be screened with plan materials so that no more than two-thirds of the surface of the fence will be visible within three years after erection of the New Tower from a public street or any adjoining lot zoned a residential district.
- f. A street protective yard of at least 20 feet in width measured perpendicular to the street right-of-way will be maintained along the boundary of the Parcel with the right of way of Maywood Avenue. This street protective yard will comply with the requirements of Section 10-2082.5 of the City Code. The Parcel does not adjoin any lot containing a dwelling, congregate care, or congregate living structure or zoned a residential district.
- g. The output power from the New Tower shall not exceed federally approved levels for exposure to electronic magnetic force (EMF).
- h. The Applicant is not aware of any determination by the City that the new Tower is situated in a location which will benefit the City's telecommunications systems.
- i. The proposed location of the New Tower is not within 1,000 feet of a tower greater than 100 feet in height.
- j. The New Tower is not located within an Historic Overlay district or Metro Park Protection Overlay District.
- k. The New Tower will be utilized to broadcast the signal of Radio Stations WQDR-AM and WCLY-AM.
- l. As shown on the Site Plan, at least 600 square feet has been reserved on the site for each telecommunication user for associated buildings and equipment or evidence will be offered at the hearing that less space is necessary.

- m. With this Application, the applicant shall provide evidence that the New Tower meets FAA requirements and is in accordance with all tower requirements and standards of the Raleigh Durham Airport Authority.
 - n. The Parcel is not zoned a residential district.
- o. The Existing Tower has operated for a number of years safely and in harmony with the surrounding area. The New Tower will be the same height as the Existing Tower and will be situated similarly upon the Parcel. Accordingly, the New Tower will not be injurious to property or improvements in the affected area.
 - p. Within twelve months of the approval of the Special Use Permit for the New Tower, a grading permit, building permit or zoning permit will be obtained and within eighteen months of such approval the New Tower will be installed and operational.

CONCLUSIONS OF LAW

- 1. The requirements of the Raleigh City Code 10-2145 have been met and the applicant, Curtis Media Group, is entitled to a special use permit for a Telecommunication Tower.
- 2. Pursuant to the provisions of G.S. 160A of the North Carolina General Statutes, the City Council is empowered to place conditions upon a special use permit. The following Special Use Condition is imposed:


No microwave dishes shall be placed on the tower unless mandated by a federal law or regulative prompting local regulation.

3. The request made in SU-5-10 is hereby approved.

This the 21st day of September, 2010.

Gail G. Smith City Clerk

Prepared by the Raleigh City Attorney's Office

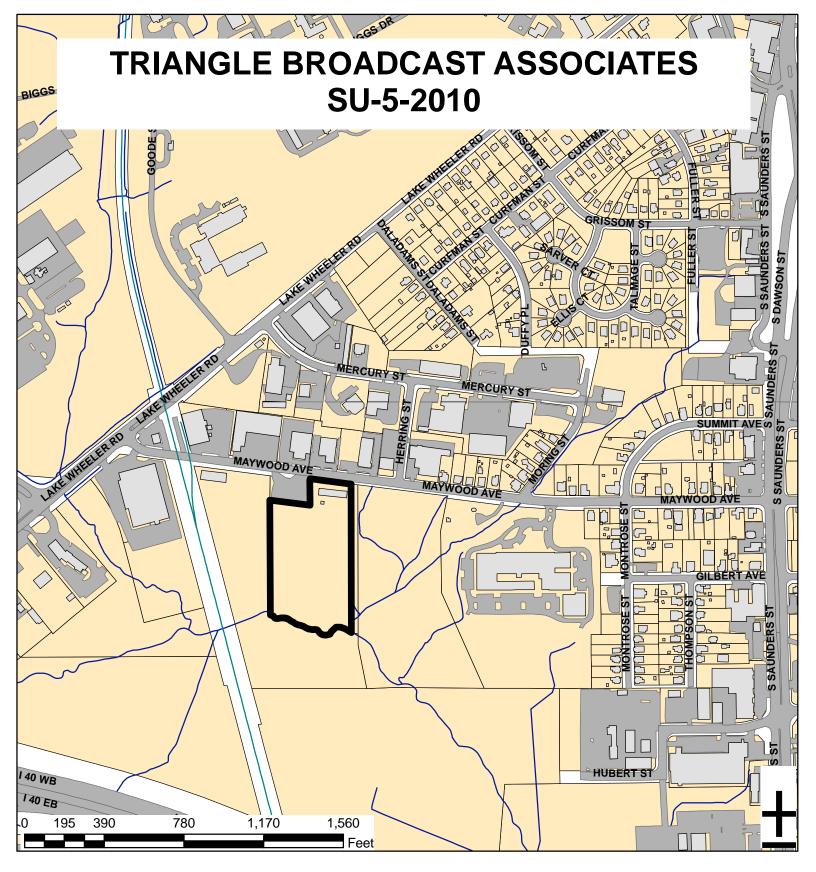

Zoning: IND-2

CAC: Southwest

Drainage

Basin: Walnut Creek

Acreage: 6.06


Proposed Use: 280" Guyed Telecom. Tower

Planner: Jacque Baker
Phone: (919) 516-2630
Applicant Contact: Allen Sherrill
Phone: (919) 882-3730

Directions From Curits Media Office:

TAKE HIGHWOODS BLVD. TOWARD CAPITAL BLVD. / US-1 / US-401S. TURN RIGHT ONTO CAPITAL BLVD. [US-1 / US-401] AND GO 3.6 MILES. CONTINUE ON N DAWSON ST. (US 70 E), GO 1.4 MILES. CONTINUE TO FOLLOW US 70 E, GO 0.3 MILE. TURN RIGHT ON MAYWOOD AVE. SITE IS ON THE RIGHT.

SITE DIRECTIONS

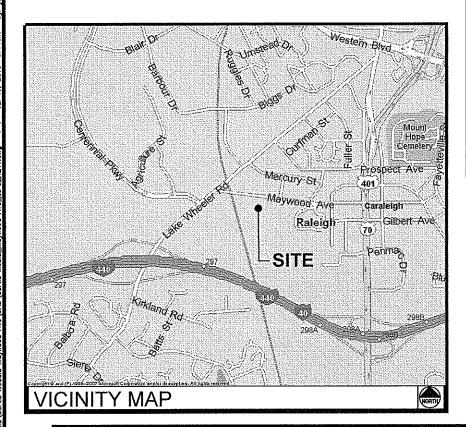

CURTIS MEDIA GROUP

SITE NAME: MAYWOOD AVE

ADDRESS:

649 MAYWOOD AVE RALEIGH, NC 27603 **WAKE COUNTY**

TOWER TYPE: GUYED TOWER

TOWER HEIGHT: 280' AGL

LATITUDE: 35° 45′ 37″ N

LONGITUDE: 78° 39' 25" W

EXISTING GROUND ELEVATION: 244.5' AMSL

PROPOSED GROUND ELEVATION: 246.5' AMSL

TAX MAP # (PIN): 1703117788

ZONING: IND2

ADJACENT ZONING DISTRICTS: IND2, CUD R10

SITE DRAWINGS

SHEET

NUMBER DESCRIPTION

T-1 TITLE SHEET

APPENDIX B BUILDING CODE SUMMARY

SITE SURVEY (SHEET 1 OF 3)

SITE SURVEY (SHEET 2 OF 3)

SITE SURVEY (SHEET 3 OF 3)

T-2 **EXISTING SITE PLAN**

T-3 **GENERAL NOTES**

C-1 **OVERALL SITE LAYOUT** <u>/1</u>\

C-2 SITE PLAN

C-3 **GRADING & EROSION CONTROL PLAN**

C-4 **CONSTRUCTION DÉTAILS**

C-5 **FENCING DETAILS**

C-6 **EROSION CONTROL DETAILS**

E-1 BASIC SERVICE ROUTING PLAN

E-2 **GROUNDING PLAN**

E-3 SINGLE LINE DIAGRAM

ELECTRICAL DETAILS

E-5 H-FRAME DETAILS

ELECTRICAL DETAILS

CONSTRUCTION **DRAWINGS**

CURTIS MEDIA GROUP

3012 HIGHWOODS BLVD. RALEIGH, NC 27604


CONSULTANT / CERTIFICATES:




and Associates, Inc. NC License F-0102 Post Office Box 33068 Raleigh, North Carolina 27636

DRAWN BY: JGA CHECKED BY: KVR DRAWING DATE: 07/19/10

SPACE RESERVED FOR PROFESSIONAL SEALS

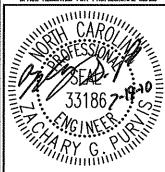

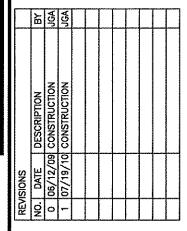

MAYWOOD AVE TOWER

649 MAYWOOD AVE RALEIGH, NC WAKE COUNTY

SHEET TITLE

TITLE SHEET

SHEET NUMBER

CONSULTANT

KIMLEY-HORN AND ASSOCIATES, INC. TRIANGLE BROADCAST ASSOC. 3001 WESTON PARKWAY **CARY, NORTH CAROLINA 27513** PHONE: (919) 677-2098 ATTN: KENT VAN RIPER

PROPERTY OWNER

C/O CURTIS MEDIA 3012 HIGHWOODS BLVD, SUITE 201 RALEIGH, NC 27604 ATTN: ALLEN SHERRILL PHONE: (919) 882-3730

POWER COMPANY

PROGRESS ENERGY PHONE: (800) 452-2777 ATTN: CUSTOMER SERVICE

TELEPHONE COMPANY

BELLSOUTH PHONE: (800) 620-6900 ATTN: CUSTOMER SERVICE


PROJECT MANAGER **CURTIS MEDIA**


3012 HIGHWOODS BLVD, SUITE 201 RALEIGH, NC 27604 ATTN: ALLEN SHERRILL PHONE: (919) 882-3730


CITY OF RALEIGH ONE EXCHANGE PLAZA, SUITE 404


PERMITTING INFORMATION


RALEIGH, NC 27602 PHONE: (919) 516-2150 ATTN: PLANS REVIEWER

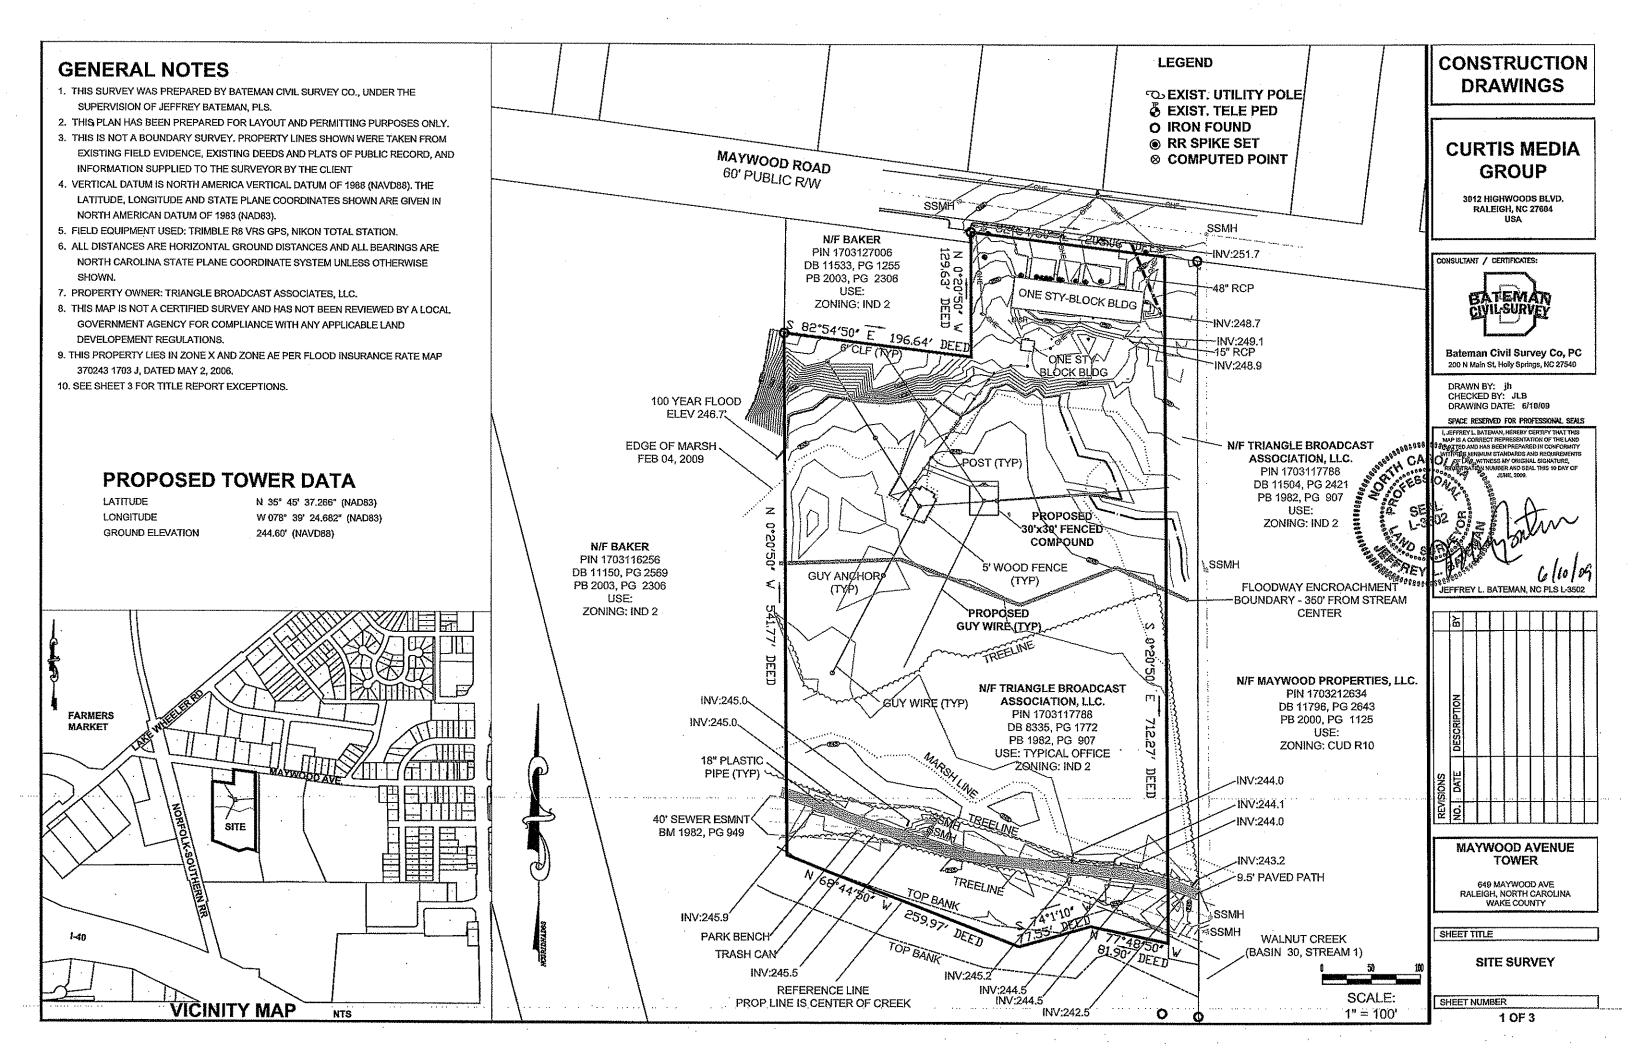


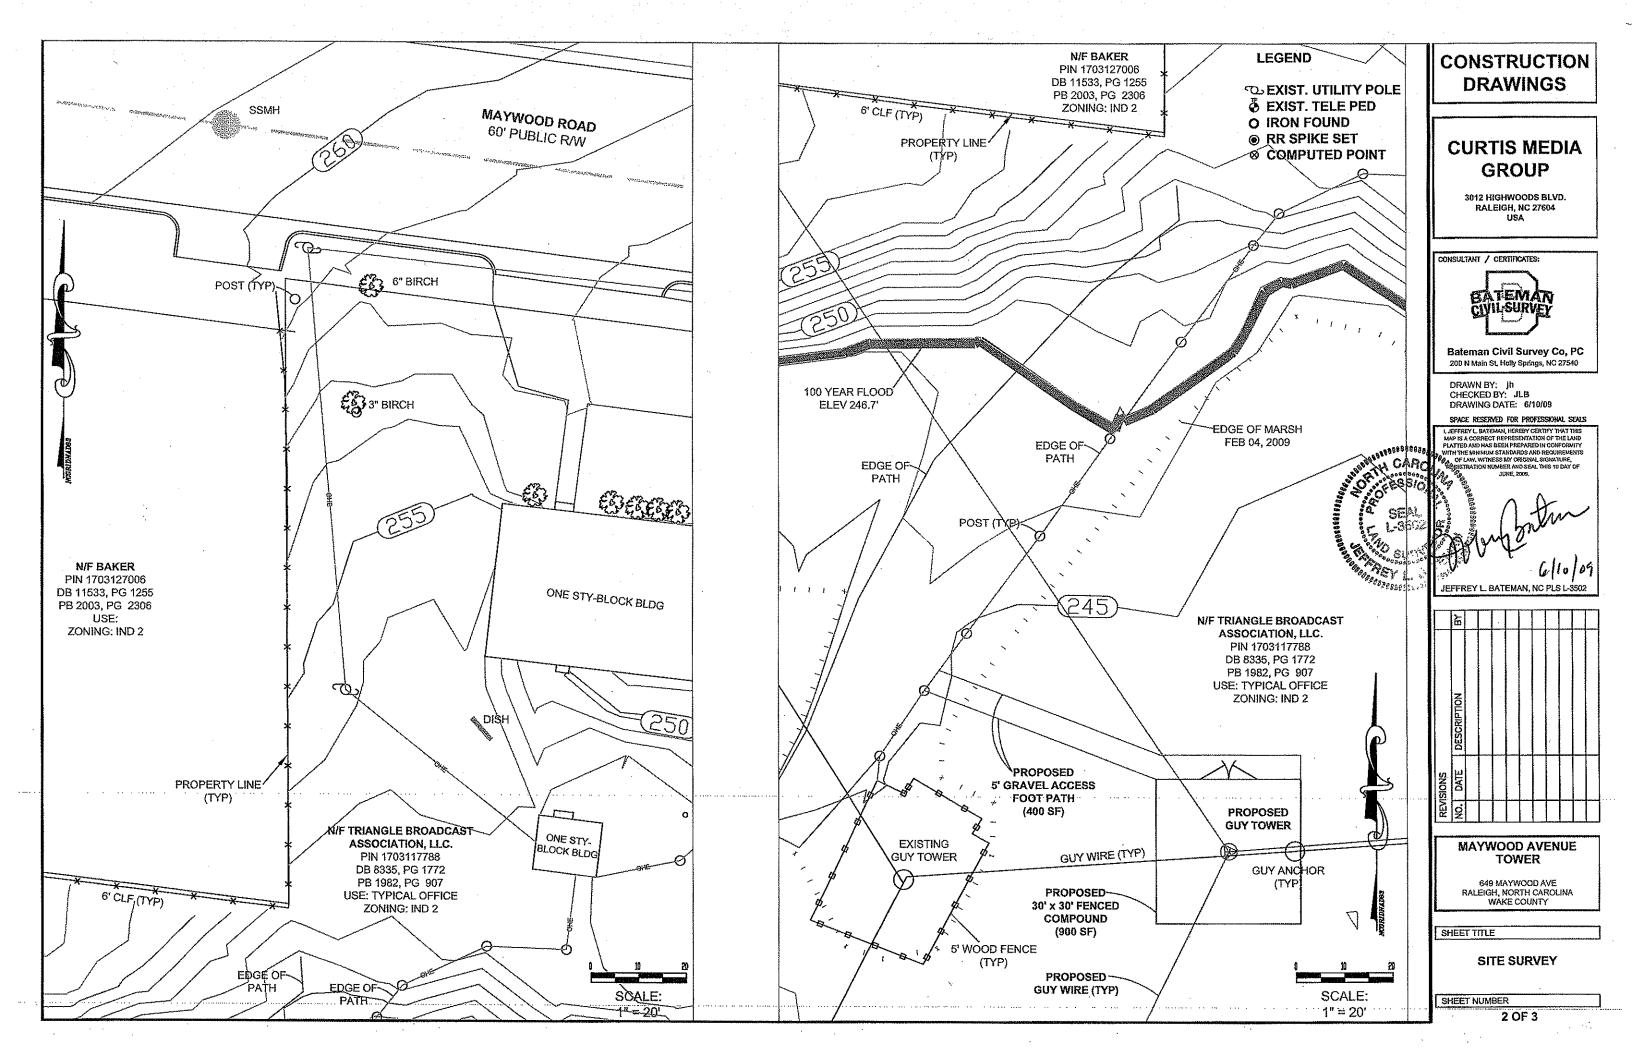


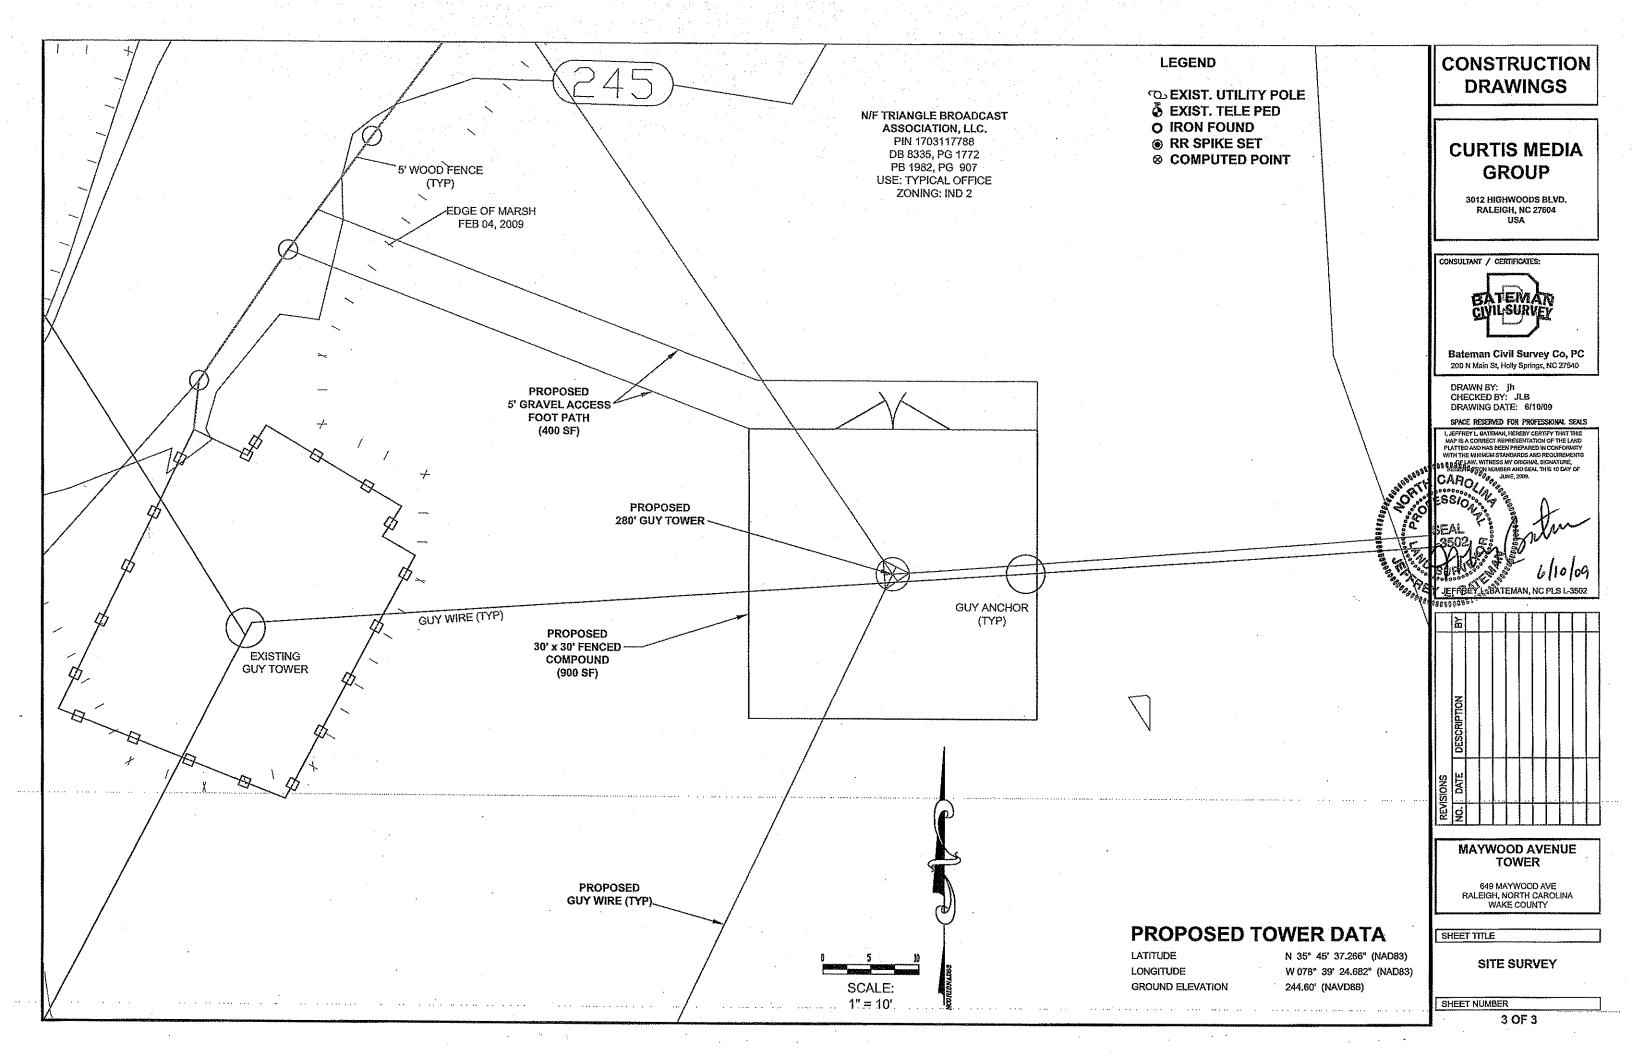


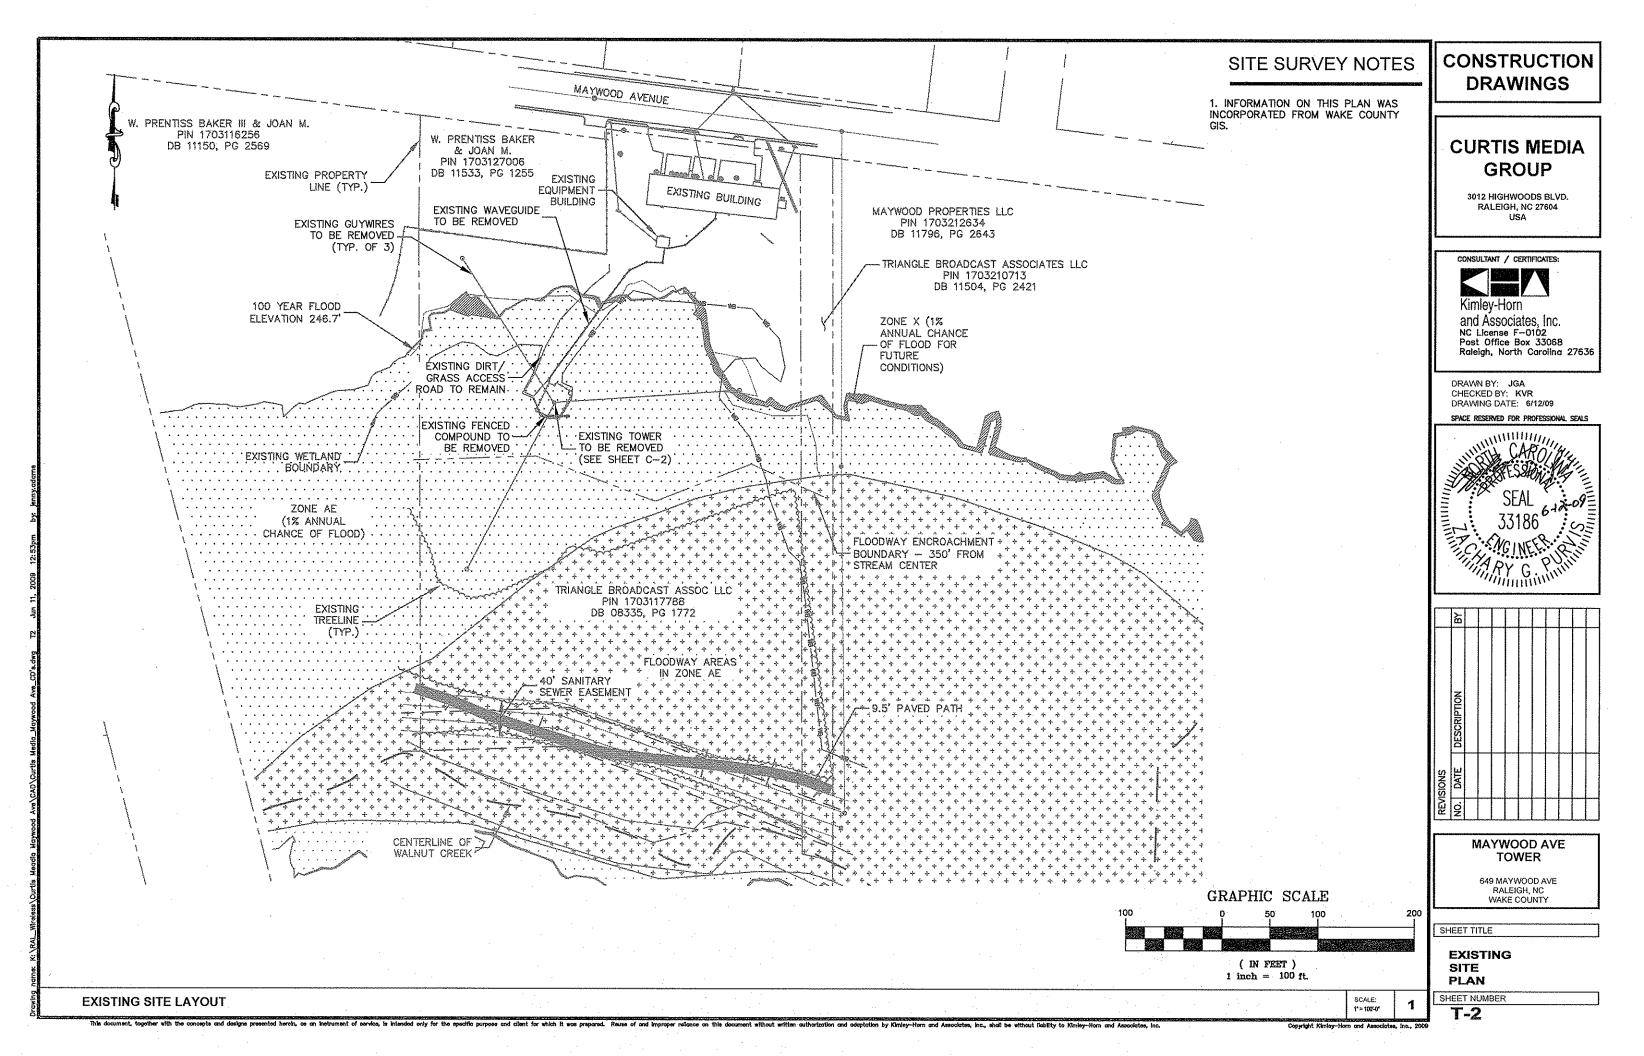


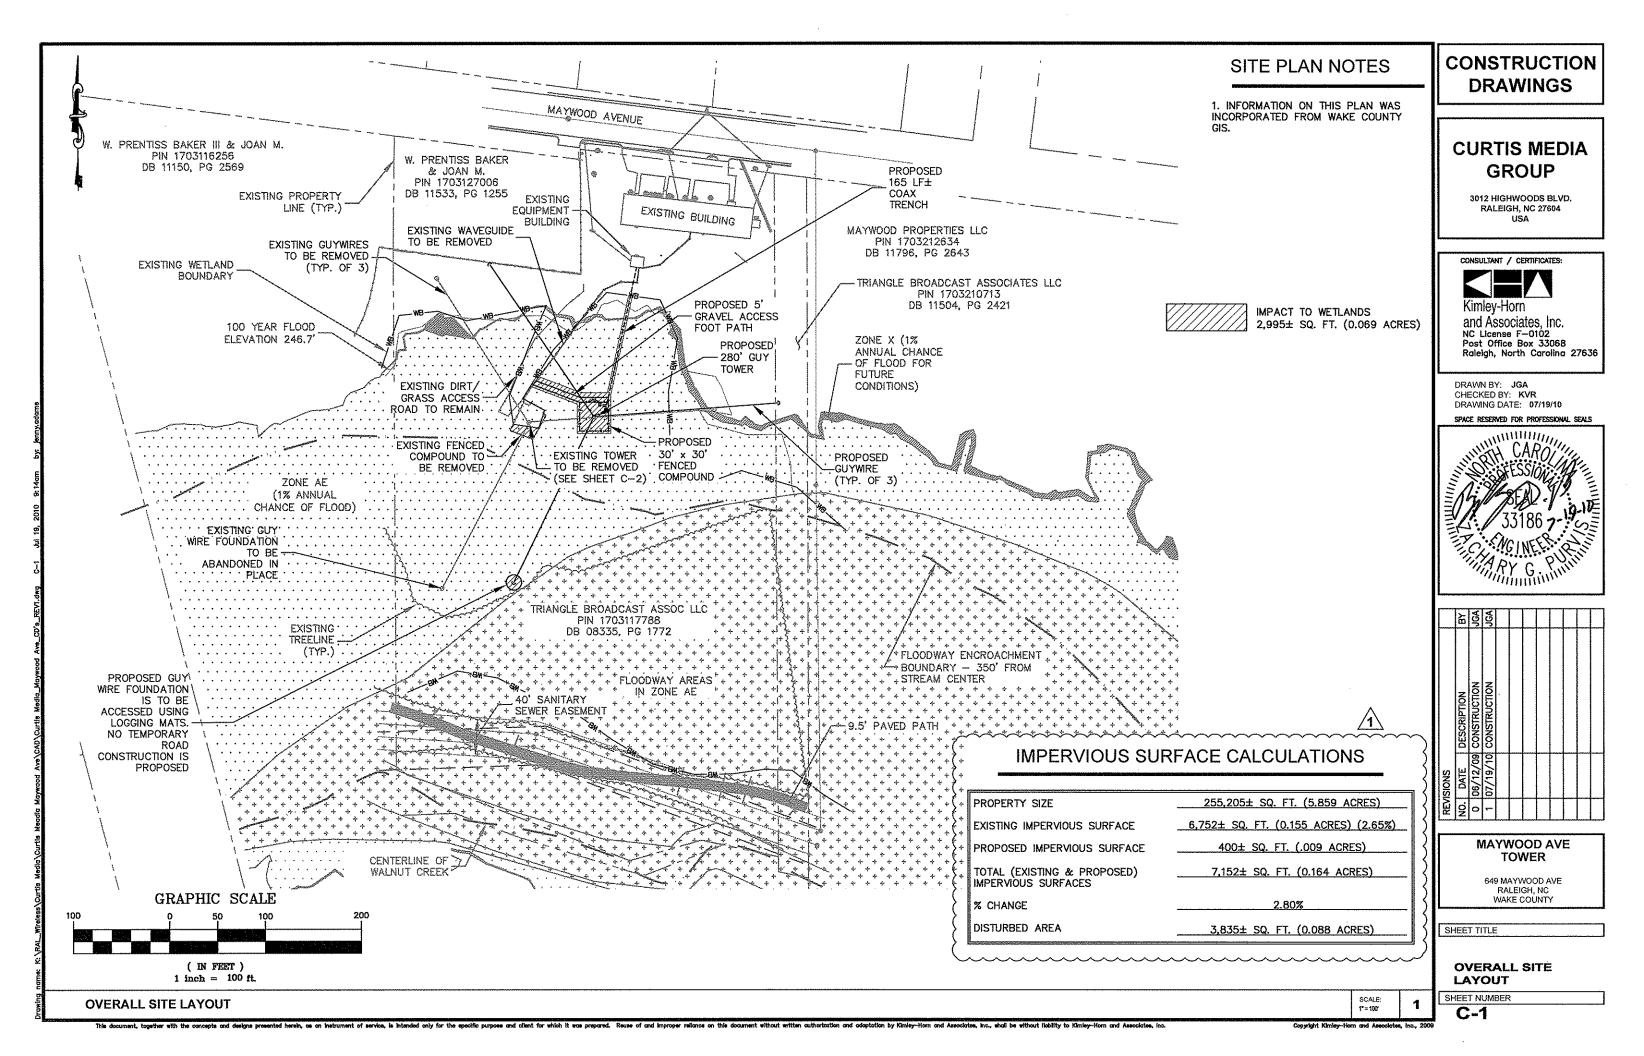

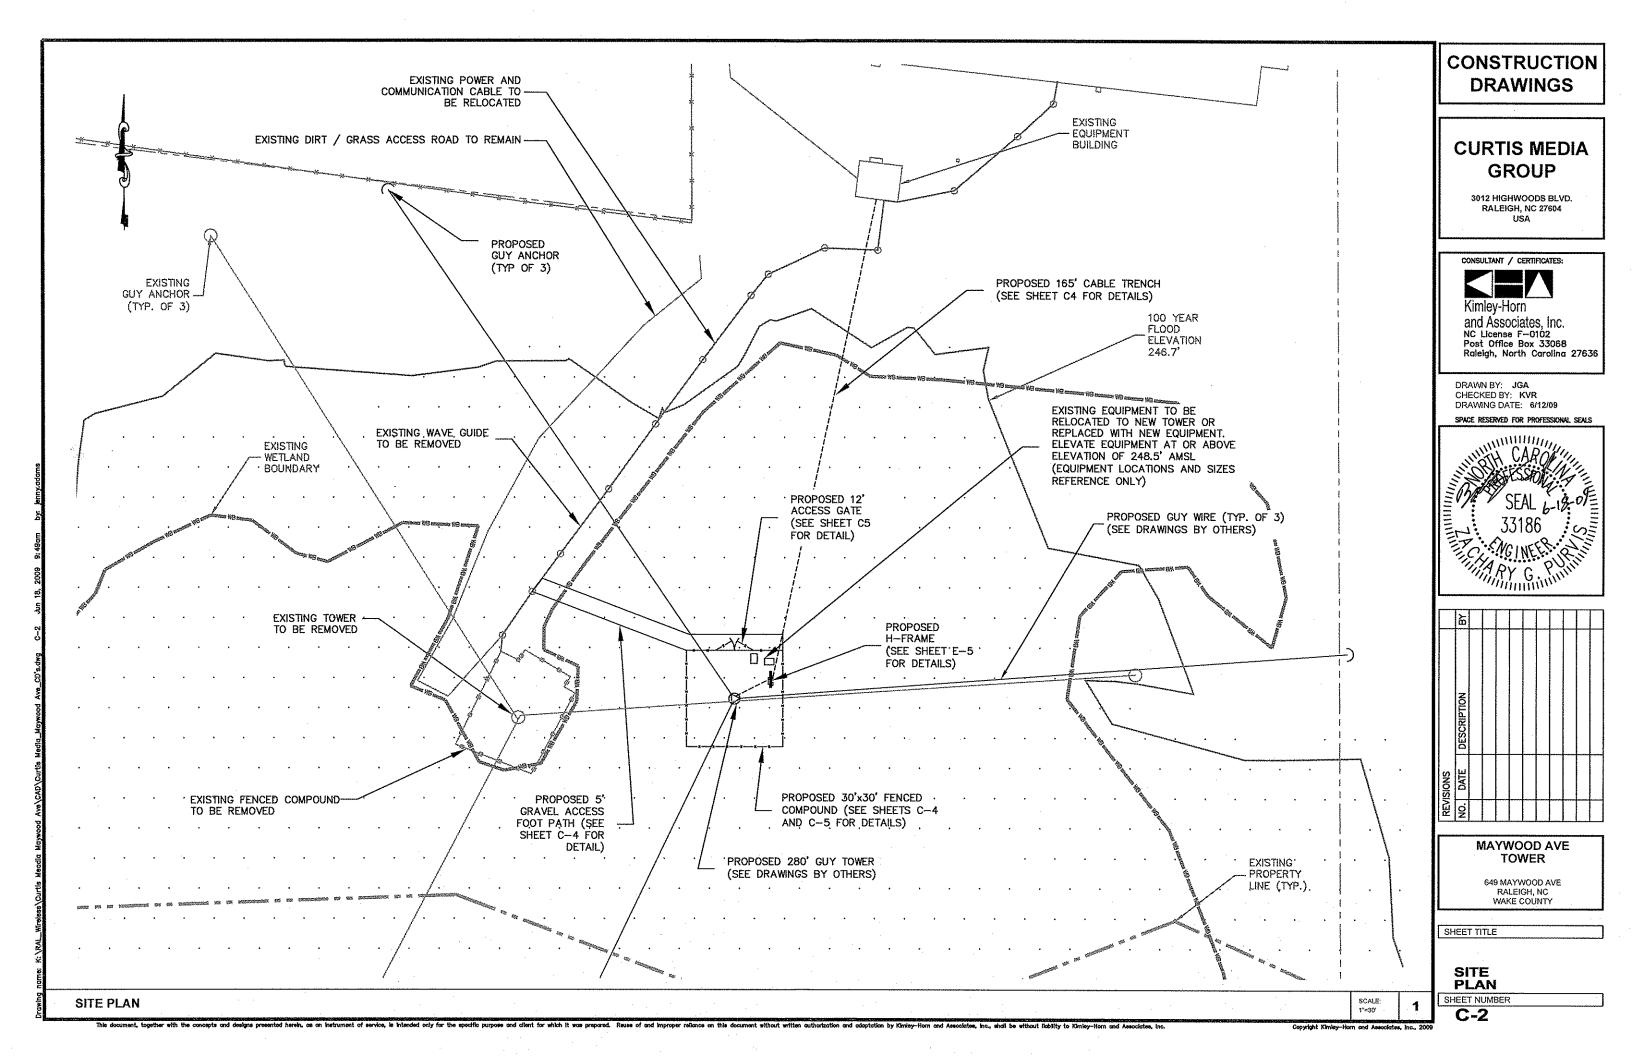

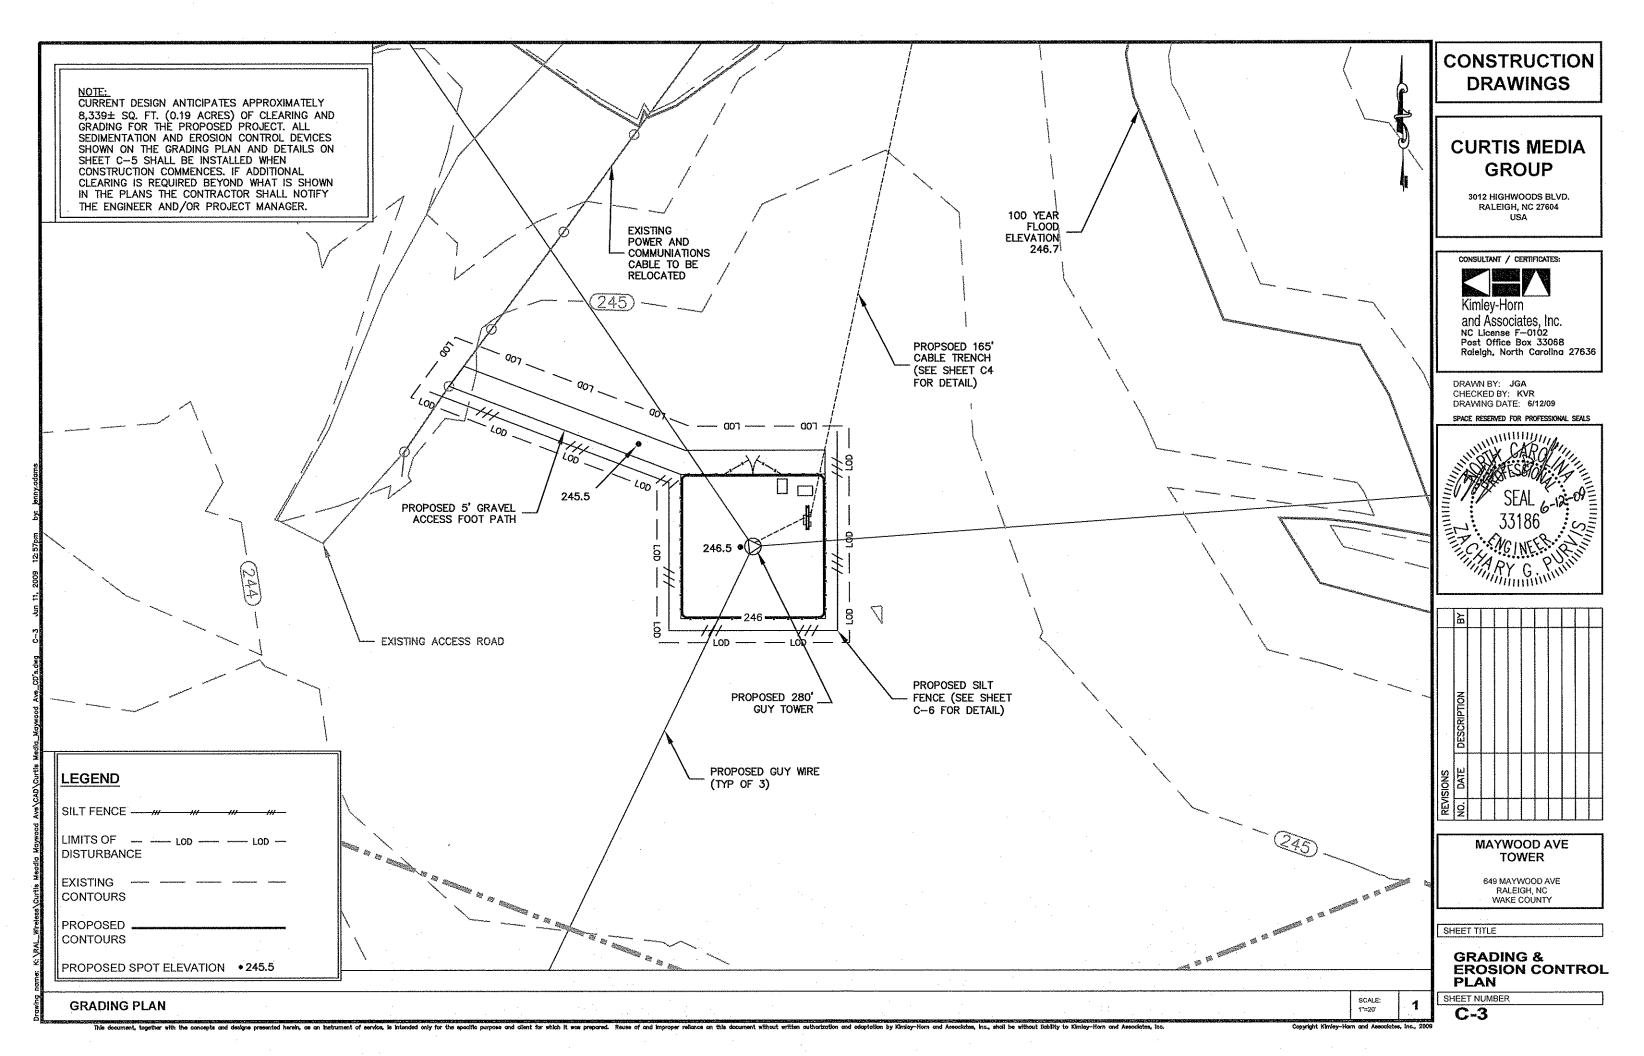

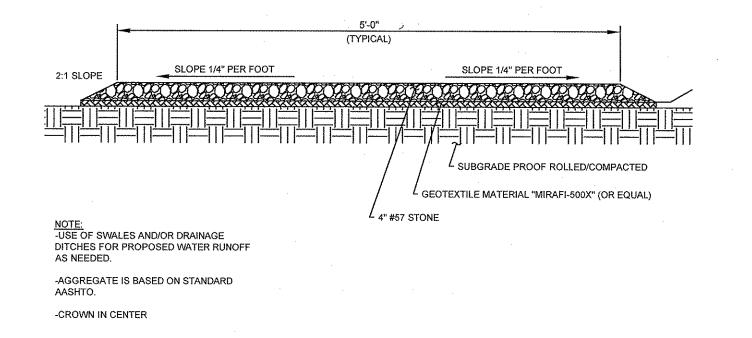

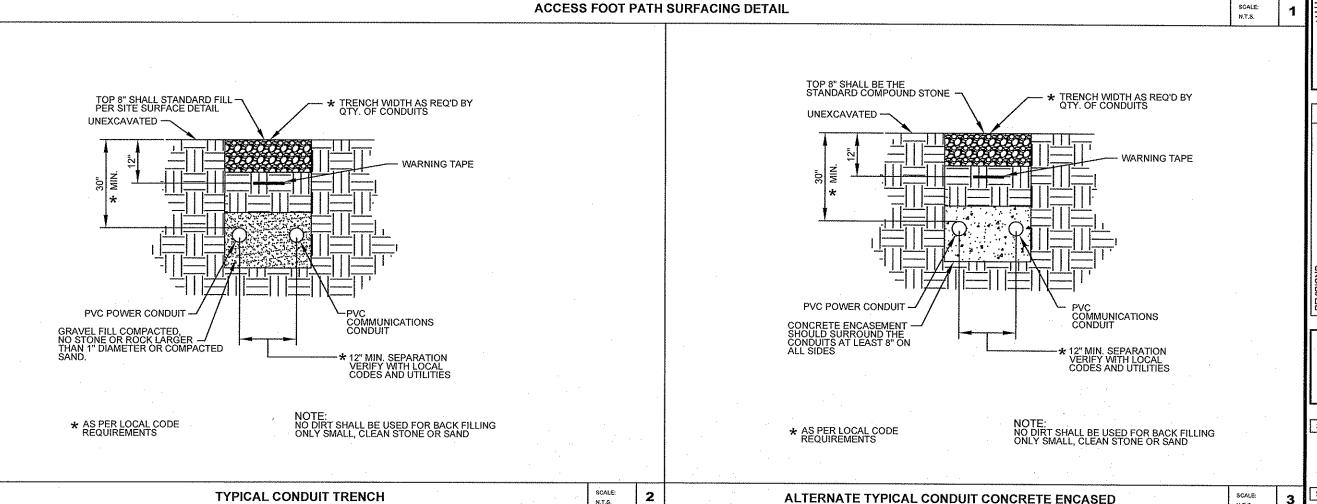

CONSTRUCTION DRAWINGS

CURTIS MEDIA GROUP

3012 HIGHWOODS BLVD. RALEIGH, NC 27604

CONSULTANT / CERTIFICATES:





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DRAWING DATE: 6/12/09

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MAYWOOD AVE TOWER

649 MAYWOOD AVE RALEIGH, NC WAKE COUNTY

SHEET TITLE

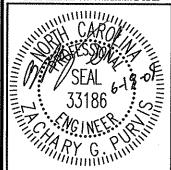CONSTRUCTION DETAILS

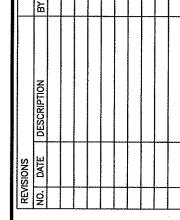
SHEET NUMBER


C-4

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- USE 3,000-PSI CONCRETE, FULLY CONSOLIDATED AROUND THE POST.
- WHERE THE POST IS SET IN ROCK OR CONCRETE, CORE A HOLE 12" DEEP AND 1" LARGER IN DIAMETER THAN THE POST. SET THE POST AND GROUT IN PLACE USING NON-SHRINK GROUT
- 3. ALL POSTS MUST BE PLUMB AND ALIGNED WITH ONE ANOTHER IN BOTH HORIZONTAL AND VERTICAL PLANES.
- 4. CORNERS AND GATEPOSTS FOR CHAIN LINK FENCES SHALL EXTEND ABOVE THE TOP STRAND OF BARBED WIRE TO PROVIDE TENSIONING FOR THE BARBED WIRE.
- 5. PROVIDE MIDRAILS AND BRACING AT ALL CORNER POSTS WHERE THE FENCE CHANGES DIRECTION BY MORE THAN 30 DEGREES.
- 6. THE GRADE OF THE SITE AND INSTALLATION OF THE FENCE SHALL PROVIDE FOR NO MORE THAN A 1" GAP BETWEEN THE BOTTOM OF THE FENCE MATERIAL AND FINISH GRADE.
- 7. CONTRACTOR SHALL PROVIDE HOLD OPEN DEVICES FOR ALL GATES AT THE SPECIFIED OPEN POSITIONS, DRIVEN PIPE TYPE RECEIVERS ARE NOT AUTHORIZED.
- 8. CONTRACTOR SHALL ALSO PROVIDE A MUSHROOM TYPE RECEIVER AT THE CLOSE POSITION.



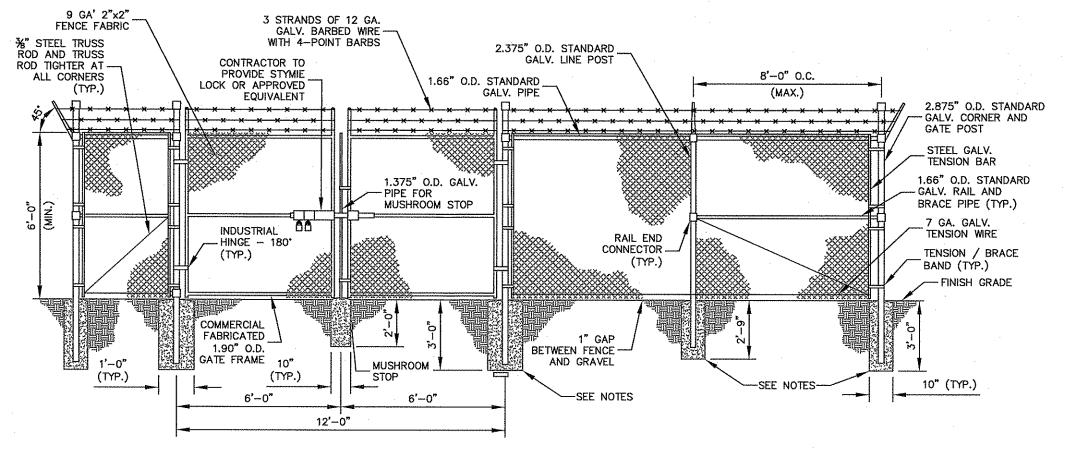

CONSTRUCTION DRAWINGS

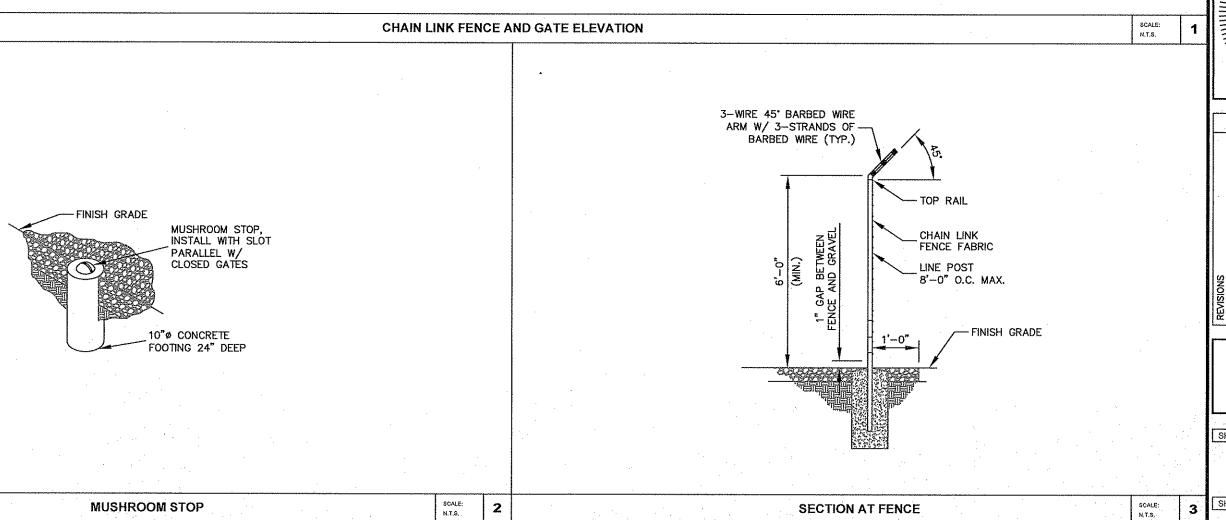CURTIS MEDIA GROUP

3012 HIGHWOODS BLVD. RALEIGH, NC 27604

CONSULTANT / CERTIFICATES:





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MAYWOOD AVE TOWER

649 MAYWOOD AVE RALEIGH, NC WAKE COUNTY

SHEET TITLE


FENCING DETAILS

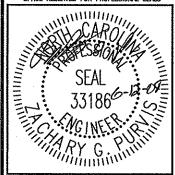C-5
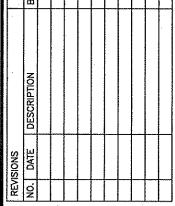
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EROSION CONTROL NOTES

- EROSION CONTROLS SHALL BE INSTALLED PRIOR TO CONSTRUCTION AND SHALL BE ADEQUATE TO MAINTAIN SEDIMENT ON SITE.
- ALL EXCAVATED SOILS NOT NEEDED ON SITE FOR BACKFILL OPERATIONS SHALL BECOME PROPERTY OF THE CONTRACTOR AND SHALL BE TAKEN OFF SITE AND LEGALLY DISPOSED OF.
- SOIL REMAINING ON SITE SHALL HAVE SILT FENCE TIGHTLY PLACED AROUND THE ENTIRE CIRCUMFERENCE OF THE PILE.
- PROVIDE EROSION CONTROLS AS NECESSARY TO PREVENT EXISTING SOILS FROM DRAINING OFF SITE OR INTO EXISTING DRAINAGE STRUCTURES.
- ERECTION OF EROSION CONTROLS SHALL BE IN ACCORDANCE WITH STATE AND LOCAL EROSION CONTROL REGULATIONS.

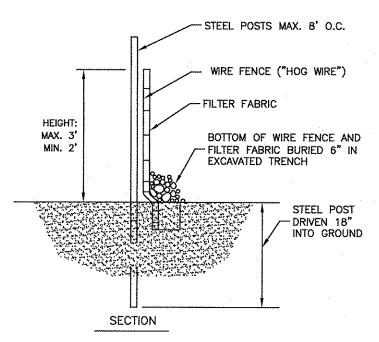

POST MAY BE EITHER 4" DIAMETER PINE. WEATHERPROOF SIGN SEE NOTES BELOW FOR CONSTRUCTION AND SPACING DATA. 2" DIAMETER OAK, OR 1.33 Ib/LF STEEL-5'-0" O.C. MAXIMUM ORANGE, UV RESISTANT, -HIGH-TENSILE STRENGTH, POLY BARRICADE FABRIC TREE PROTECTION AREA DO NOT ENTER ZONA DE PROTECSION PARA ARBOLES - NO ENTRA SUBGRÁDE, ... NOTES INSTALL TREE PROTECTION FENCE AND SIGNAGE PRIOR TO CALLING FOR

SEDIMENT FENCE (SILT FENCE)

1 N.T.S.

TREE PROTECTION FENCE

SITE INSPECTION. MAINTAIN TREE PROTECTION FENCE THROUGHOUT DURATION OF PROJECT. SIGNS SHALL BE PLACED AT 50' MAXIMUM INTERVALS.

SEEDING SCHEDULE FOR WINTER / SPRING

SEEDING MIXTURE

Species Rate (lb/acre) Rye (grain) Annual lespedeza (Kobe in

CONSTRUCTION ACTIVITIES

Piedmont and Coastal Plain. Korean in Mountains)

Omit annual lespedeza when duration of temporary cover is not to extend beyond June.

SEEDING DATES

Mountains-- Above 2500 ft: Feb 15 - May 15 Below 2500 ft.: feb. 1 - May 1 Piedmont--Jan. 1 - May 1 Coastal Plain--Dec. 1 - Apr. 15

SOIL AMENDMENTS

Follow recommendations of soil tests or apply 2,000 lb/acre ground agricultural limestone and 750 lb/acre 10-10-10 fertilizer.

Apply 4,000 lb/acre straw. Anchor straw by tacking with asphalt, netting, or a mulch anchoring tool. A disk with blades set nearly straight can be used as a mulch anchoring tool.

MAINTENANCE

Refertilize if growth is not fully adequate. Reseed. refertilize and mulch immediately following erosion or other damage.

SEEDING SCHEDULE FOR SUMMER **CONSTRUCTION ACTIVITIES**

SEEDING MIXTURE

Species Rate (lb/acre) Common Bermudagrass 40-80 (1-2 lb/1,000 sg. ft.)

SEEDING DATES

Coastal Plain—Apr. 1 — July Piedmont—Apr. 15 — June 30

SOIL AMENDMENTS

Apply lime and fertilizer according to soil tests, or apply 3,000 lb/acre ground agricultural limestone and 500 lb/acre 10-10-10 fertilizer.

MULCH

Use jute, excelsior matting, or other effective channel lining material to cover the bottom of channels and ditches. The lining should extend above the highest calculated depth of flow. On channel side slopes above this height, and in drainages not requiring temporary lining, apply 4,000 lb/acre grain straw and anchor straw by stapling netting over the top.

MAINTENANCE

A minimum of 3 weeks is required for establishment. Inspect and repair mulch frequently. Refertilize the following Apr. with 50 lb/acre nitrogen.

PERMANENT SEEDING SCHEDULE FOR **CONSTRUCTION ACTIVITIES**

SEEDING MIXTURE

Species	Rate (lb/acre)
Tall fescue	80
Pensacola Bahiagrass	50
Sericea lespedeza	30
Kobe lespedeza	10

SEEDING NOTES

- 1. From Sept. 1 Mar. 1, use unsacrified sericea seed. 2. On poorly drained sites, omit sericea and increase Kone to 30 lb/acre.
- 3. Where a neat appearance is desired, omit sericea and increase Kobe to 40lb/acre.

Nurse Plants

Between Apr. 15 and Aug. 15, add 10 lb/acre German millet or 15 lb/acre Sundangrass. Prior to May 1 or after Aug. 15, add 25 lb/acre rye (grain).

SEEDING DATES

	Dest	rossible
ariy sprin	g: Feb. 15-Mar. 20	Feb. 15-Apr. 30
all:	Sept. 1-Sept. 30	Sept. 1-Oct. 31

SOIL AMENDMENTS

Apply lime and fertilizer according to soil tests, or apply 3,000-5,000 lb/acre ground agricultural limestone (use the lower rate on sandy soils) and 1,000 lb/acre 10-10-10 fertilizer.

Apply 4,000 lb/acre grain straw or equivalent cover of another suitable mulch. Anchor straw by tacking with asphalt, netting, roving, or by crimping with a mulch anchoring tool. A disk with blades set nearly straight can be used as a mulch anchoring tool.

MAINTENANCE

If growth is less than fully adequate, refertilize in the second year, according to soil tests or top dress with 500 lb/acre 10-10-10 fertilizer. Mow as necessary. Reseed, fertilize, and mulch damaged areas immediately.

CONSTRUCTION **DRAWINGS**

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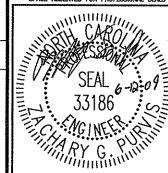
CONSULTANT / CERTIFICATES:




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MAYWOOD AVE TOWER

649 MAYWOOD AVE RALEIGH, NC

SHEET TITLE

EROSION CONTROL DETAILS

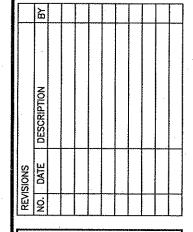
SHEET NUMBER

C-6

SEEDING NOTES

SCALE:

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NOTES AND SPECIFICATIONS:

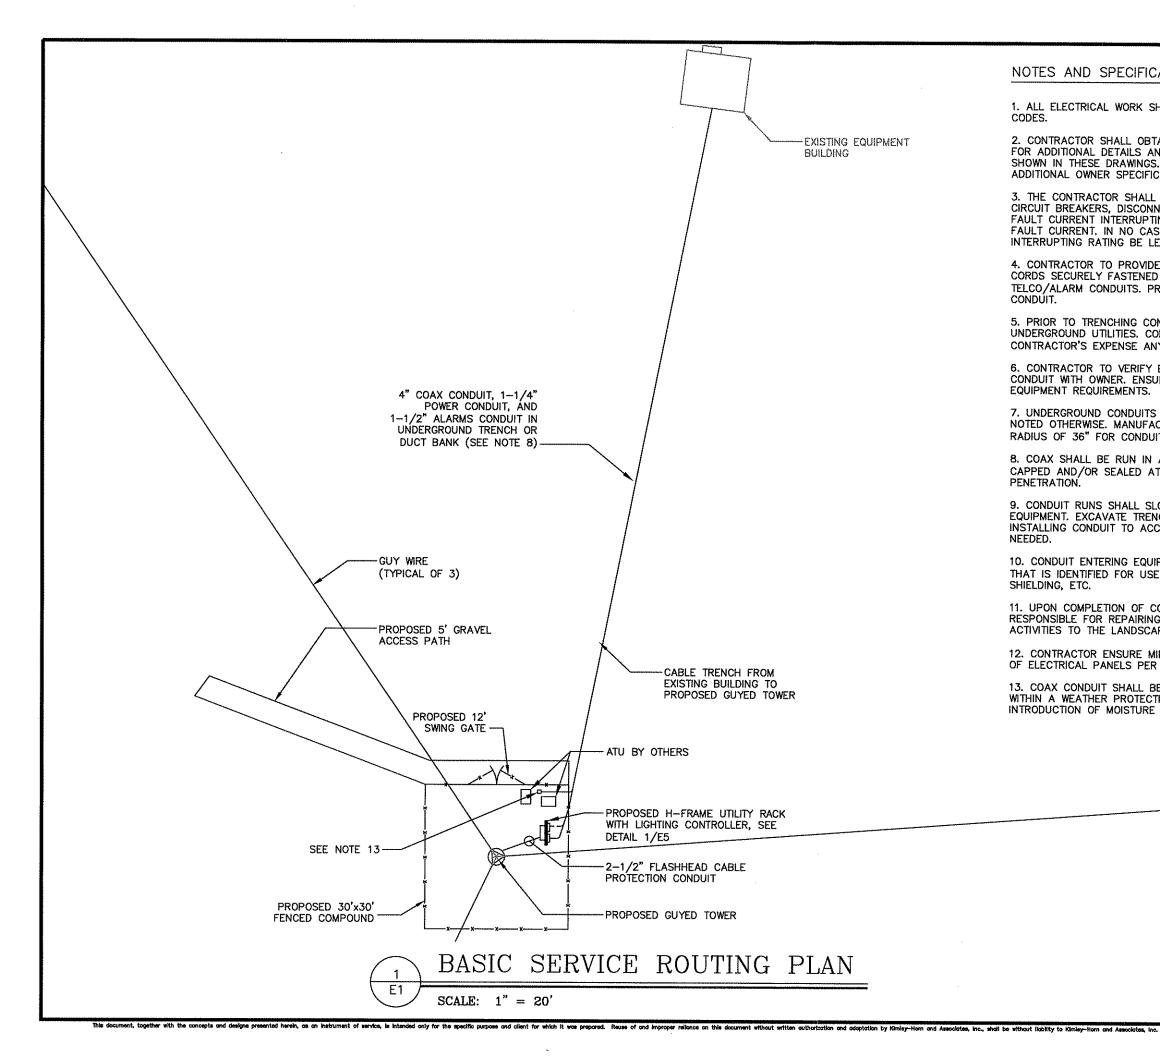- 1. ALL ELECTRICAL WORK SHALL COMPLY WITH NEC, STATE, AND LOCAL CODES.
- 2. CONTRACTOR SHALL OBTAIN OWNER SPECIFICATIONS AND REVIEW FOR ADDITIONAL DETAILS AND REQUIREMENTS THAT MAY NOT BE SHOWN IN THESE DRAWINGS. CONTRACTOR SHALL COMPLY WITH ANY ADDITIONAL OWNER SPECIFICATIONS AND REQUIREMENTS.
- 3. THE CONTRACTOR SHALL ENSURE ALL ELECTRICAL EQUIPMENT. CIRCUIT BREAKERS, DISCONNECTS, FUSES, AND PANELBOARDS HAVE A FAULT CURRENT INTERRUPTING RATING GREATER THAN THE AVAILABLE FAULT CURRENT, IN NO CASE SHALL THE FAULT CURRENT INTERRUPTING RATING BE LESS THAN 10,000 AMPS.
- 4. CONTRACTOR TO PROVIDE 2-200 LB TEST POLYETHYLENE PULL CORDS SECURELY FASTENED AT EACH END OF COAX, POWER, AND TELCO/ALARM CONDUITS. PROVIDE CAPS ON ENDS OF UNUSED
- 5. PRIOR TO TRENCHING CONTRACTOR SHALL LOCATE ALL EXISTING UNDERGROUND UTILITIES. CONTRACTOR SHALL REPAIR AT CONTRACTOR'S EXPENSE ANY DAMAGE TO EXISTING UTILITIES.
- 6. CONTRACTOR TO VERIFY EXACT ROUTING OF POWER AND TELCO CONDUIT WITH OWNER. ENSURE ALL CONDUIT STUB-UPS ACCOMMODATE EQUIPMENT REQUIREMENTS.
- 7. UNDERGROUND CONDUITS SHALL BE SCHEDULE 40 PVC UNLESS NOTED OTHERWISE. MANUFACTURED BENDS SHALL HAVE A MINIMUM RADIUS OF 36" FOR CONDUIT.
- 8. COAX SHALL BE RUN IN A CONTINUOUS RUN OF RIBBED HDPE, CAPPED AND/OR SEALED AT BOTH ENDS TO PREVENT MOISTURE PENETRATION.
- 9. CONDUIT RUNS SHALL SLOPE DOWNWARD AND AWAY FROM THE EQUIPMENT. EXCAVATE TRENCHES ALONG STRAIGHT LINES PRIOR TO INSTALLING CONDUIT TO ACCOMMODATE ADJUSTING THE ELEVATION, AS
- 10. CONDUIT ENTERING EQUIPMENT SHALL BE SEALED WITH A SEALANT THAT IS IDENTIFIED FOR USE WITH THE CABLE/CONDUCTOR INSULATION, SHIELDING, ETC.
- 11. UPON COMPLETION OF CONSTRUCTION, CONTRACTOR IS RESPONSIBLE FOR REPAIRING ANY DAMAGE CAUSED BY CONSTRUCTION ACTIVITIES TO THE LANDSCAPING AREA.
- 12. CONTRACTOR ENSURE MINIMUM 3' WORKING CLEARANCE IN FRONT OF ELECTRICAL PANELS PER NEC.
- 13. COAX CONDUIT SHALL BE TERMINATED WITH WEATHERHEAD OR WITHIN A WEATHER PROTECTIVE ENCLOSURE & SEALED TO PREVENT INTRODUCTION OF MOISTURE INTO CONDUIT.



Consulting Group, PA 7330 Chapel Hill Road Suite 202 Raleigh, N.C. 27607 N.C. License # C-1848 (919) 858-7420 Fax (919) 858-7423 ACG PROJECT NO.: 2009 049


CURTIS MEDIA GROUP

3012 HIGHWOODS BLVD. RALEIGH, NC 27604



and Associates, Inc. Post Office Box 33068 Raleigh, North Carolina 27636 KHA JOB #: 012928002

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MAYWOOD AVE TOWER

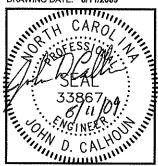
649 MAYWOOD AVE RALEIGH, NC WAKE COUNTY

SHEET TITLE

BASIC SERVICE ROUTING PLAN

SHEET NUMBER

E-1

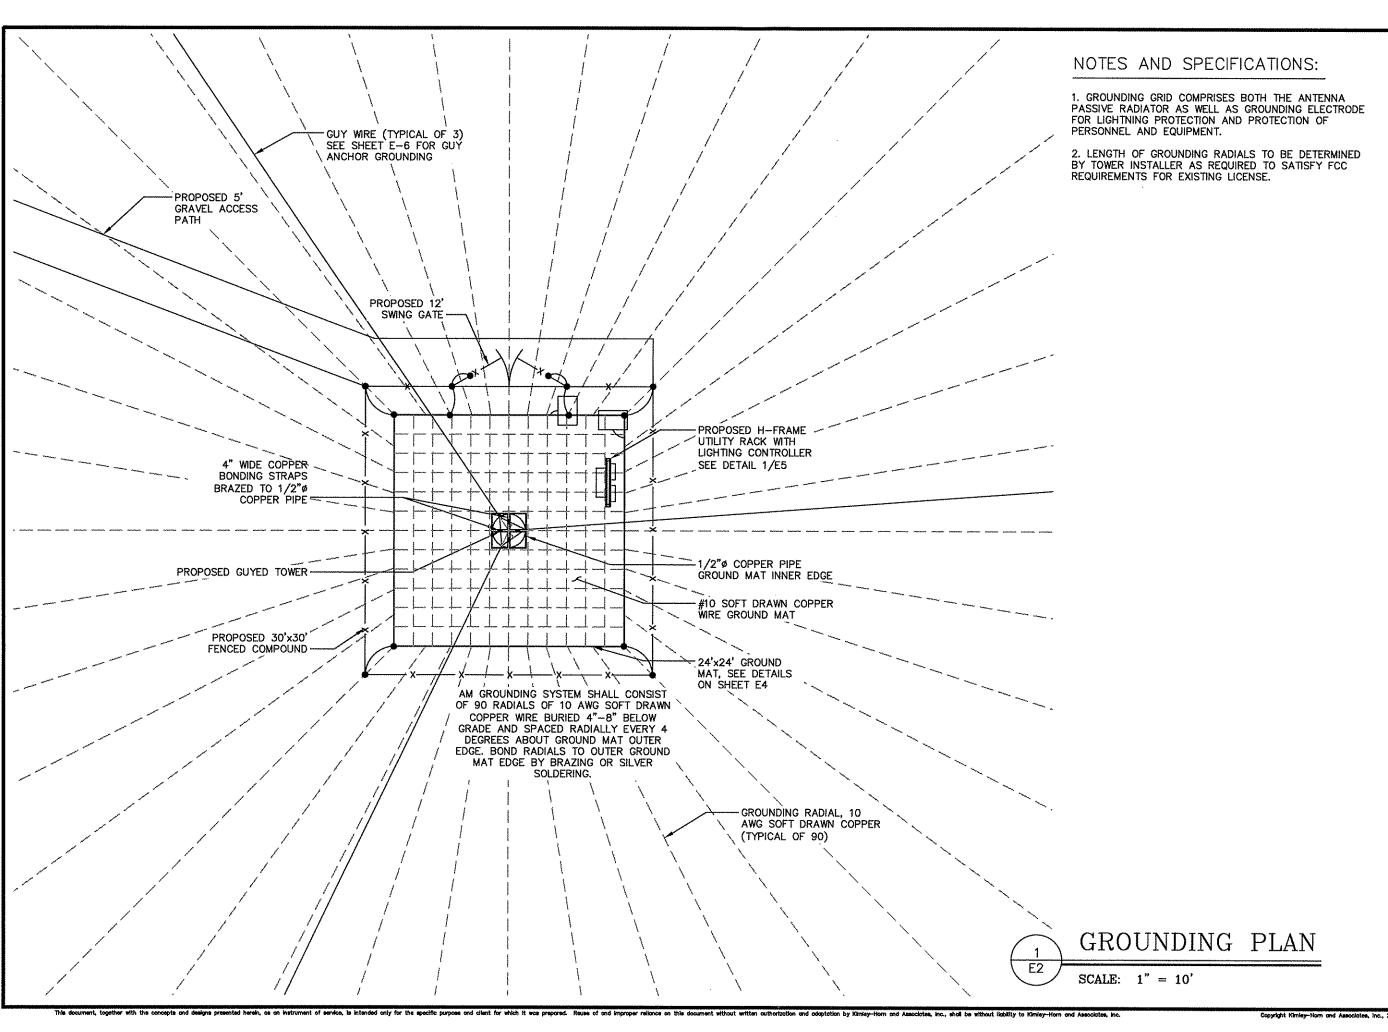



Consulting Group, PA
7330 Chapel Hill Road Suite 202
Rateigh, N.C. 27607
N.C. License # C-1848
(919) 858-7420 Fax (919) 858-7423
ACG PROJECT NO.: 2009 049


CURTIS MEDIA GROUP

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MAYWOOD AVE TOWER


649 MAYWOOD AVE RALEIGH, NC WAKE COUNTY

SHEET TITLE

GROUNDING PLAN

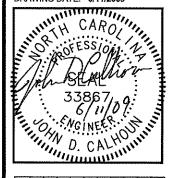SHEET NUMBER

OFFICE F NOIVE

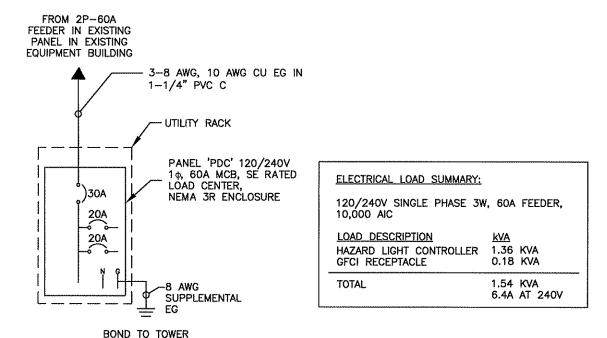

SINGLE-LINE DIAGRAM SCALE: NOT TO SCALE

GROUND MAT

NOTES AND SPECIFICATIONS:

- 1. ALL ELECTRICAL WORK SHALL COMPLY WITH NEC, STATE, AND LOCAL CODES.
- 2. CONTRACTOR SHALL OBTAIN OWNER EQUIPMENT DRAWINGS AND REVIEW FOR ADDITIONAL DETAILS AND REQUIREMENTS THAT MAY NOT BE SHOWN IN THESE DRAWINGS. CONTRACTOR SHALL COMPLY WITH ANY ADDITIONAL OWNER SPECIFICATIONS AND REQUIREMENTS.
- 3. THE CONTRACTOR SHALL ENSURE ALL ELECTRICAL EQUIPMENT, CIRCUIT BREAKERS, DISCONNECTS, FUSES, AND PANELBOARDS HAVE A FAULT CURRENT INTERRUPTING RATING GREATER THAN THE AVAILABLE FAULT CURRENT. IN NO CASE SHALL THE FAULT CURRENT INTERRUPTING RATING BE LESS THAN 10,000 AMPS.
- 4. THE GROUNDED SERVICE CONDUCTOR (NEUTRAL CONDUCTOR) SHALL BE GROUNDED AT THE SERVICE DISCONNECT ONLY.
- 5. ALL POWER CIRCUITS SHALL USE COPPER CONDUCTORS WITH THHN/THWN INSULATION. ALL TERMINATIONS SHALL BE RATED FOR AT LEAST 75 DEGREES C.
- 6. CONTRACTOR SHALL PROVIDE GROUND FAULT CIRCUIT INTERRUPTER (GFCI) TYPE RECEPTACLES FOR ALL UTILITY RECEPTACLES.
- 7. CONTRACTOR SHALL ENSURE ALL NEUTRAL CONDUCTORS HAVE WHITE INSULATION AND EQUIPMENT GROUND CONDUCTORS HAVE GREEN INSULATION. COLOR TAPE IDENTIFICATION OF THESE CONDUCTORS IS NOT ALLOWED.
- 8. 120V, 20A CIRCUITS SHALL CONSIST OF 2-12 AWG, 12 AWG EG IN 3/4" CONDUIT UNLESS NOTED OTHERWISE.




Consulting Group, PA
7330 Chapel Hill Road Suite 202
Raleigh, N.C. 27607
N.C. License # C-1848
(919) 858-7420 Fax (919) 858-7423
ACG PROJECT NO.: 2009 049

CURTIS MEDIA GROUP

3012 HIGHWOODS BLVD. RALEIGH, NC 27604 USA



DRAWN BY: JCH CHECKED BY: JDC DRAWING DATE: 6/11/2009

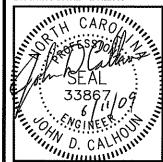

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MAYWOOD AVE TOWER


649 MAYWOOD AVE RALEIGH, NC WAKE COUNTY

SHEET TITLE

SINGLE-LINE DIAGRAM


SHEET NUMBER

E-3

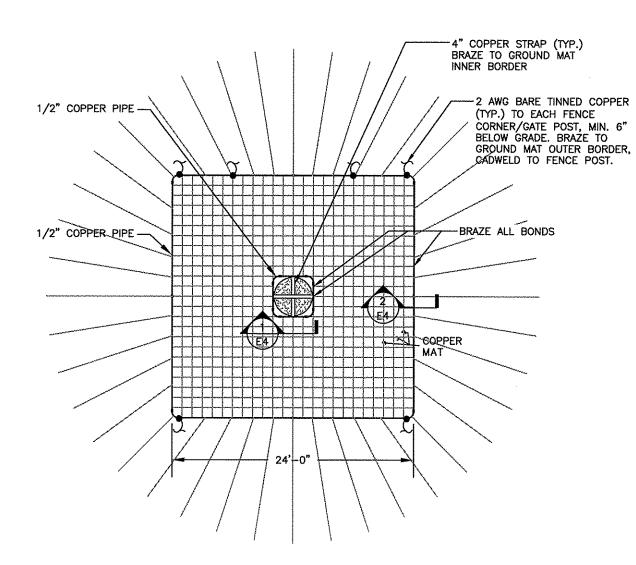


GROUNDING MAT DETAIL

SCALE: NOT TO SCALE

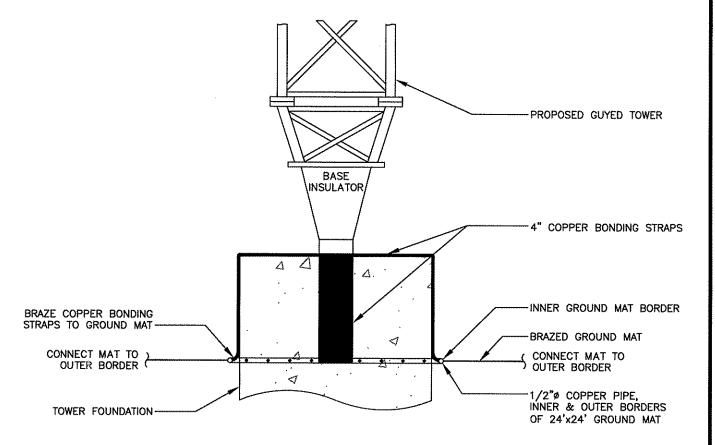

TOWER AND INNER MAT GROUNDING DETAIL

SCALE: NOT TO SCALE

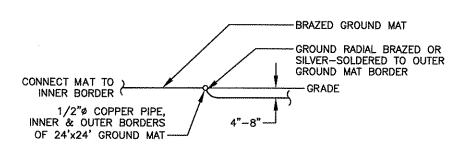

RADIAL AND OUTER MAT GROUNDING DETAIL

SCALE: NOT TO SCALE

APOGEE
Consulting Group, PA

7330 Chapel Hill Road Suits 202 Raleigh, N.C. 27607 N.C. License # C-1846 (919) 858-7420 Fax (919) 858-7423 ACG PROJECT NO.: 2009 049


CURTIS MEDIA GROUP


3012 HIGHWOODS BLVD. RALEIGH, NC 27604



and Associates, Inc.
Post Office Box 33068
Raleigh, North Carolina 27636
KHA JOB #: 012928002

DRAWN BY: JCH CHECKED BY: JDC DRAWING DATE: 6/11/2009

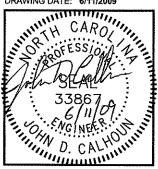

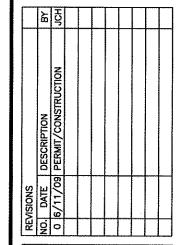

MAYWOOD AVE TOWER

649 MAYWOOD AVE RALEIGH, NC WAKE COUNTY

SHEET TITLE

ELECTRICAL DETAILS

SHEET NUMBER

E-4

ocument, together with the concepts and designs presented herein, as an instrument of service, is intended only for the specific purpose and client for which it was prepared. Reuse of and improper reliance on this document without written authorization and adaptation by Kimley-Horn and Associates, inc., shall be without stability to Kimley-Horn and Associates, inc.

Consident Kiming-Storm and Associates Sur. 20

GENERAL NOTES:

1-ALL WORK SHALL CONFORM TO THE NATIONAL ELECTRICAL CODE, STATE BUILDING CODES AND THE LOCAL BUILDING CODES. ALL COMPONENTS SHALL BE U.L. LISTED.

2-REFER TO SITE LAYOUT PLAN FOR THE EXACT LOCATION OF H-FRAME.

3-CONTRACTOR TO LOCATE RACK TO ENSURE WORKING SPACES REQUIRED BY THE NEC (ART. 110.26), STATE, OR LOCAL CODES ARE MAINTAINED BOTH ON THE FRONT SIDE AND THE BACK SIDE OF THE H-FRAME.


4-SHOW LOCATION (INCLUDING DIMENSIONS) OF ALL CAPPED UNDERGROUND CONDUIT ON FINAL AS-BUILT DRAWINGS SUBMITTED TO OWNER.

5-COORDINATE EXACT LOCATION OF UNDERGROUND FEEDERS AND CIRCUITRY WITH THE OWNER.

6-CONTRACTOR SHALL COORDINATE EFFORTS WITH (LOCAL, ELECTRICAL) AUTHORITY HAVING JURISDICTION (AHJ) AND OTHER TRADES TO DETERMINE "FROST" LINE, AND TYPE(S) OF RACEWAYS REQUIRED FOR INSTALLATION.

7-DIMENSIONS SHOWN ARE APPROXIMATE AND MAY BE ALTERED IN THE FIELD AS APPROVED BY OWNER TO BETTER SUIT ACTUAL CONDITIONS OR EQUIPMENT RECEIVED.

8-FOR ANY METAL CONDUIT ENTERING AN ENCLOSURE WHERE A PRE-PUNCHED CONCENTRIC OR ECCENTRIC KNOCKOUT IS USED, THE CONTRACTOR SHALL ENSURE ADEQUATE BONDING BETWEEN THE METAL CONDUIT AND ENCLOSURE BY INSTALLING A BONDING JUMPER AROUND THE CONCENTRIC OR ECCENTRIC KNOCKOUT.

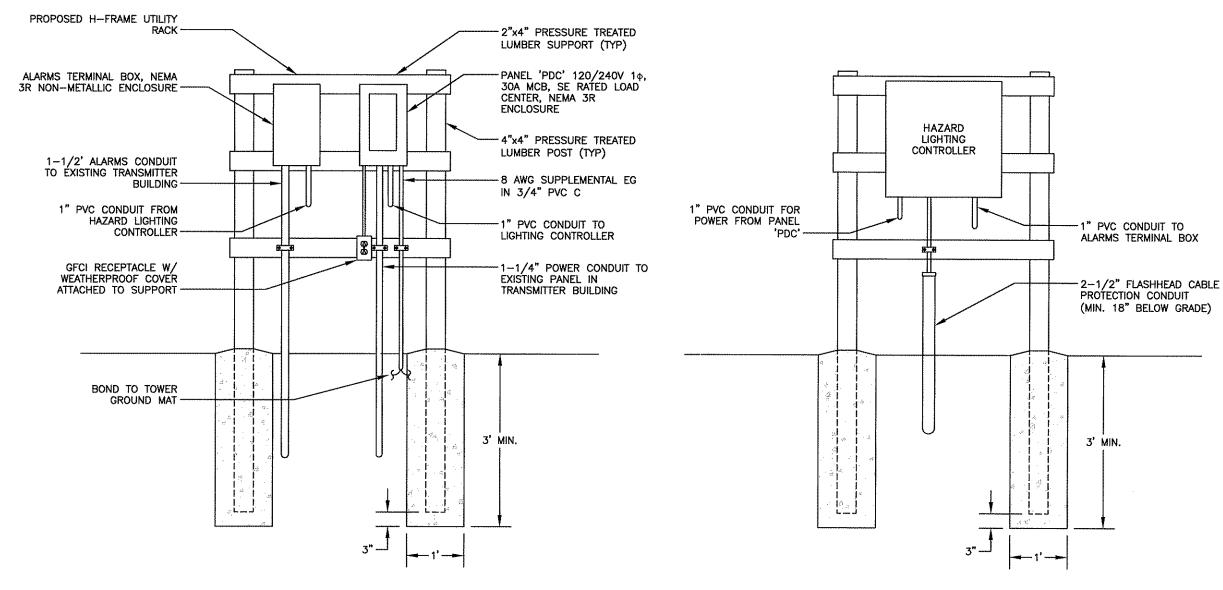

NOTE: CONSTRUCT SO CONCRETE FOOTING EXTENDS 6" BELOW FROST LINE AND IN COMPLIANCE WITH ALL LOCAL AND STATE CODES.



Consulting Group, PA

7330 Chapel Hill Road Suite 202 Rateigh, N.C. 27607 N.C. Licones # C-1848 (919) 858-7420 Fax (919) 858-7423 ACG PROJECT NO.: 2009 049

CURTIS MEDIA GROUP


3012 HIGHWOODS BLVD. RALEIGH, NC 27604



KHA JOB #: 012928002

DRAWN BY: JCH

DRAWN BY: JCH CHECKED BY: JDC DRAWING DATE: 6/11/2009

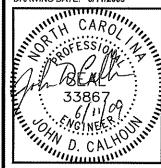

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	DATE	6/11/09				
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MAYWOOD AVE TOWER

649 MAYWOOD AVE RALEIGH, NC WAKE COUNTY

SHEET TITLE
H-FRAME

DETAILS SHEET NUMBER

E-5


SCALE: NOT TO SCALE


NOTES:

- 1. GUY WIRE INSULATORS SHALL BE AT LEAST 10'
- ABOVE GRADE.

E6


E6

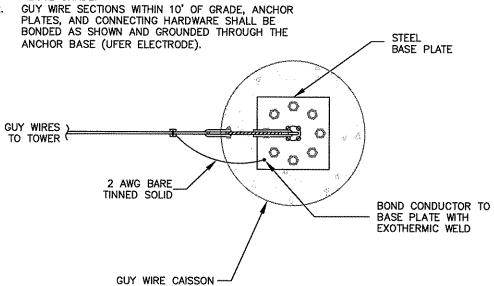

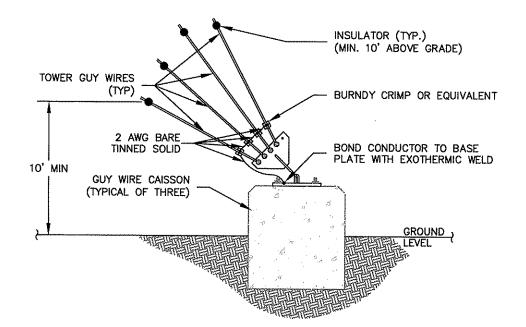

GUY ANCHOR DETAIL

SCALE: NOT TO SCALE

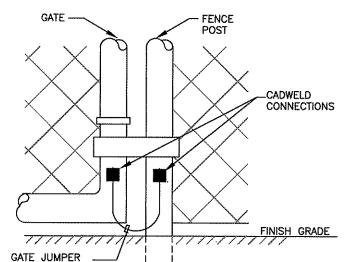


GATE GROUNDING DETAIL

SCALE: NOT TO SCALE

2/0 AWG

WELDING CABLE

GUY ANCHOR ELEVATION DETAIL SCALE: NOT TO SCALE

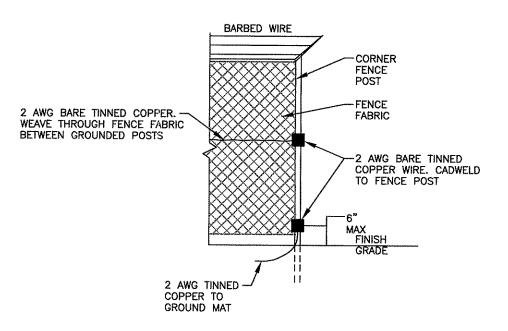

GATE GROUNDING DETAIL SCALE: NOT TO SCALE

APOGEE

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7330 Chapel Hill Road Suite 202
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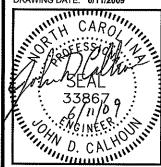
CURTIS MEDIA GROUP


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MAYWOOD AVE TOWER

649 MAYWOOD AVE RALEIGH, NC WAKE COUNTY

SHEET TITLE

ELECTRICAL DETAILS

SHEET NUMBER

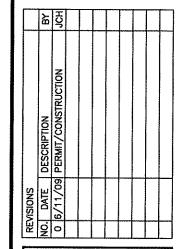City of Raleigh, NC Development Plans Review Center

P. O. Box 590, Raleigh, N. C. 27602 Telephone: (919) 516-2626 FAX: (919) 516-2684 www.raleighnc.gov

SPECIAL USE PERMIT APPLICATION

FOR PUBLIC HEARING AND APPROVAL BY THE CITY COUNCIL

Sect SUBM	AL CHECKLIST
MEM	TIME YOU SUBMIT YOU MUST VERIFY WITH A DEVELOPMENT PLANS REVIEW CENTER STAFF R THE PARCEL OR PARCELS THAT ARE THE SUBJECT OF YOUR PLAN, AND THE STAFF MEMBER HECK YOUR APPLICATION MATERIALS FOR COMPLETION.
IN TH	AN IMPORTANT STEP THAT WILL ENSURE THAT YOUR PLAN CAN BE REVIEWED AND APPROVED MINIMUM TIME POSSIBLE, SO PLEASE PLAN ON SPENDING A FEW MINUTES WITH US AT THE TIME BMIT. PLEASE <u>DO NOT</u> SIMPLY LEAVE YOUR APPLICATION MATERIALS ON THE DESK.
PLEA ARRI	CALL AHEAD FOR AN APPOINTMENT IF YOU WISH THE MOST PROMPT SERVICE WHEN YOU
	NCLUDE ALL OF THE FOLLOWING (CHECK OFF). If any information is missing from the application package, you we complete the application and re-submit the petition, so please check the list below carefully before you submit:
	206 FILING FEE . Checks may be made out to the City of Raleigh. Payments may be made by cash or by check, but not or credit cards.
	HREE ORIGINALS OF THIS APPLICATION FORM completed (Section B), signed by the property and notarized.
	HREE COPIES OF PROPOSED PLANS. Maximum sheet size shall be 30" x 42". Plans must be to engineering scale " = 20', 1" =100', etc.). Preliminary plans do not need an engineer's, surveyor's or landscape architect's seal. formation shown on the plan should relate to the findings that must be made by the City Council to grant this special usquest. See Section 10-2145 or applicable parts of Chapter 12 of the Raleigh City Code for specific findings the Council to make for this special use.
	IEW! A DIGITAL COPY OF ONLY THE PLAN LAYOUT AND ELEVATIONS. the purpose of this image is to illustrate the basic character of the preliminary plan. It should contain only successic information as: building outline, landscaping, parking and drives, stormwater facilities, lot boundary. The gital image should be provided in the form of pdf on a CD. If the plan was not digitally created, provide an 8 ½" x 11" duction of the plan.

PROCEDURE FOR HEARING AND APPROVAL OF A SPECIAL USE PERMIT BY CITY COUNCIL:

It is very important that this application be complete, the adjacent property owners list be accurate, and the signature of the property owner be notarized! A special use hearing is a quasi-judicial proceeding, and the special use permit may be invalidated if any information is inaccurate or incomplete.

If a preliminary site plan is submitted for approval along with this special use request, both plans will be forwarded to City Council approx. 6 weeks from submittal. If only the special use permit is being requested the case will be heard by City Council approx. 4 weeks from submittal.

You, or your representative must be present at the hearing to present the case for issuance of the special use permit. You will be notified as to the time and place of the proceeding. City staff will provide a written draft set of findings for the Council to consider. A coordinating planner will contact you and will provide a draft of the special use findings for you prior to the hearing.

Section B. SUMMARY INFORMATION - (SHOW ON PLAN)	
DEVELOPMENT NAME: Triangle Broadcast Associates, L LOCATION: South Side of Maywood Avenue, East of Lake	
SHOW WAKE COUNTY PROPERTY IDENTIFICATION SUBMITTAL CHECKLIST ON FRONT PAGE.	NUMBER(S) ON PLAN. SUBMIT PIN MAP. SEE
ZONING DISTRICT: Industrial-2	TOTAL SITE ACRES: 6.06
SPECIAL USE PERMIT REQUESTED:	
 ■ Telecommunication tower. □ Correctional / Penal facility. □ Additional Density in O&I, TC, SC Districts. □ Outdoor Stadium (more than 250 seats). □ Amplified Music (indoor / outdoor) (Code section 12-212). 	☐ Parking facility in a residential district. ☐ Recreation use (membership) in primary watershed ☐ Recreation use (government) or camp (non-profit) in Primary watershed 0)
OWNER / DEVELOPER:	
NAME(S): Triangle Broadcast Associates, LLC	
ADDRESS: 3012 Highwoods Boulevard, Suite 201, Raleigh, TELEPHONE: (919) 790-9392 FAX: (919) 7	
PERSON TO CONTACT REGARDING STAFF COMMENTS	S OR QUESTIONS ABOUT THE PLANS:
NAME(S): Allen Sherrill ADDRESS: 3012 Highwoods Blvd., Suite 201, Raleigh, NC 2 TELEPHONE: (919) 882-3730 FAX: (919) 7 E-MAIL ADDRESS:	27604 790-8369
THE OWNERSHIP OF THIS PROPERTY IS EVIDENCED I	BY DEED FROM: Mortensen Broadcasting Company of
AND RECORDED IN THE WAKE COUNTY REGISTRY, BO	OOK <u>8335</u> PAGE <u>1772</u>

OWNER'S SIGNATURE:			
otherwise after evidentiary hearing	on contained herein is true and com ng before the City Council, that the a	nplete; and I understand that if any item action of the Council may be invalidated	is found to be l.
Date: <u>F/22/10</u>	Signed: Triangle Broadcast Associa	tes, LLC	
STATE OF NC COUNTY OF <u>WAKE</u>	By:	Wen	Manager
I, a Notary Public, do meraby certify to before me this day and acknowledge foregoing instrument. This the day of Signed:	personally appeared d the due execution of the	Lori D Van Stone Notary Public Wake County NC My Commission Expires 11 / 8 /	SEAL
Section C. APPLICANT'S STATEMENT			
address each of the specific request. The Development Plan prepared to demonstrate that, if	uirements noted in Section 10-2145 s Review Center staff can assist in the land is used in a manner consis oposed use will comply with each or	ENTS before a special use permit may of the Raleigh Cite Code, in the area be listing the specific requirements. The appear tent with the plans, specifications and of the following specific requirements (Yellowing Specific requirements)	elow as it relates to your pplicant should be ther information
	-		
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		-	

Section D.

ADJACENT PROPERTY OWNERS (Attach additional sheets if necessary)
Include all properties immediately adjacent to or directly opposite across the street from the subject property.

Property ID No.	Property Owner	Mailing Address	Zip Code
1703127331	Davis, George H. & Linda B. Annas	656 Maywood Ave. #A, Raleigh, NC	27603-2340
1703128278	ELH Trust	319 Morrison Ave., Raleigh, NC	27608-2537
1703220245	ELH Trust	319 Morrison Ave., Raleigh, NC	27608-2537
1703127006	Baker, W. Prentiss & Joan M.	1615 Oberlin Rd., Raleigh, NC	27608-2039
1703116256	Baker, W. Prentiss III & Joan M.	1615 Oberlin Rd., Raleigh, NC	27608-2039
1703210713	Triangle Broadcast Associates LLC	3012 Highwoods Blvd., Ste. 201, Raleigh, NC	27604-1031
1703212634	Maywood Properties	1 Cypress St., Hollidaysburg, PA	16648-2705
		1	

EXHIBIT A

Applicant's Statement

This Application involves the parcel of 6.06 acres on the south side of Maywood Avenue, east of Lake Wheeler Road, which is assigned PIN 703-11-7788 (the "Parcel"). The Parcel is currently the site of a radio transmission tower (the "Existing Tower") which is 280 feet in height. The Existing Tower is a legal non-conforming use. The Applicant desires to replace the Existing Tower with a new tower (the "New Tower") of the same height. Both the Existing Tower and the New Tower are shown on the site plan (the "Site Plan") submitted with this Application. The New Tower will serve the same function as the Existing Tower, which broadcasts the radio signal of Radio Stations WQDR-AM and WCLY-AM.

The Applicant provides the following with regard to the specific requirements of Section 10-2145 of the City Code for the issuance of a Special Use Permit for a Telecommunication Tower.

- (1) As will be established by expert testimony at the hearing of this matter, the New Tower will not disturb or diminish radio or television or similar reception for adjoining properties.
 - (2) The height of the New Tower will be 280 feet, which does not exceed 510 feet.
- (3) The lighting of the New Tower will not exceed the minimum standards of the Federal Aviation Administration for a red obstruction lighting system as contained in Advisory Circular No. N70/7460-IF dated September 27, 1978, as amended.
 - (4) With regard to minimum yard setback,
- a. the yard setback exceeds the minimum of 20 feet on the north, west, and south boundaries of Parcel. Such boundaries adjoin or are across a public street from lots zoned Industrial-2 District, a non-residential district, and that are either vacant or developed without a dwelling, congregate care, or congregate living structure.
- b. the yard setback from the outside dimensions of the New Tower to Parcel PIN 1703-21-2634, which is to the east of the Parcel and is zoned Residential-10 CUD, is 222 feet. This distance is less than the 280 foot height of the New Tower, but grounds exist to support a determination by the City Council that the yard setback of 222 feet will not be injurious to property or improvements in the affected area. The reduction in setback will have very little, if any, impact upon the visibility of the Tower from the parcel zoned R-10 CUD. Further, at the hearing of this matter, engineering evidence will show that in the event of a collapse of the New Tower, no portion of the New Tower would fall outside the boundaries of the Parcel.
- (5) As shown on the Site Plan, the base of the New Tower and each guy anchor is surrounded by a fence at least eight feet in height. Except for their entrances, all fences upon the

Parcel will be screened with plant materials so that no more than two-thirds of the surface of the fence will be visible within three years after erection of the New Tower from a public street or any adjoining lot zoned a residential district.

- (6) A street protective yard of at least 20 feet in width measured perpendicular to the street right-of-way will be maintained along the boundary of the Parcel with the right of way of Maywood Avenue. This street protective yard will comply with the requirements of Section 10-2082.5 of the City Code. The Parcel does not adjoin any lot containing a dwelling, congregate care, or congregate living structure or zoned a residential district.
- (7) The output power from the New Tower shall not exceed federally-approved levels for exposure to electronic magnetic force ("EMF").
- (8) The Applicant is not aware of any determination by the City that the new Tower is situated in a location which will benefit the City's telecommunications systems.
- (9) The proposed location of the New Tower is not within 1,000 feet of a tower greater than 100 feet in height.
- (10) The New Tower is not located within an Historic Overlay District or Metro Park Protection Overlay District.
- (11) The New Tower will be utilized to broadcast the signal of Radio Stations WQDR-AM and WCLY-AM.
- (12) As shown on the Site Plan, at least 600 square feet has been reserved on the site for each telecommunication user for associated buildings and equipment or evidence will be offered at the hearing that less space is necessary.
- (13) With this Application, the Applicant shall provide evidence that the New Tower meets FAA requirements and is in accordance with all tower requirements and standards of the Raleigh Durham Airport Authority.
 - (14) The Parcel is not zoned a residential district.
- (15) The Existing Tower has operated for a number of years safely and in harmony with the surrounding area. The New Tower will be the same height as the Existing Tower and will be situated similarly upon the Parcel. Accordingly, the New Tower will not be injurious to property or improvements in the affected area.
- (16) Within six months of the approval of the Special Use Permit for the New Tower, a grading permit, building permit or zoning permit will be obtained and within one year of such approval the New Tower will be installed and operational.